GENERAL NOTES:

- MEASURES SHALL BE INSTITUTED AND MAINTAINED AROUND ALL PRESERVATION AREAS
 DURING CONSTRUCTION ACTIVITIES IN ACCORDANCE WITH THE BEST MANAGEMENT PRACTICES (BMP'S) CONTAINED IN THE STATE OF FLORIDA EROSION AND SEDIMENT CONTROL
- ESIGNER AND REVIEWER MANUAL, JULY 2013 OR EQUIVALENT. ALL AREAS DESIGNATED AS "PRESERVE" TO BE CLEARLY DELINEATED PRIOR TO INITIATION OF
- ALL CONSTRUCTION TO BE IN ACCORDANCE WITH THE SARASOTA COUNTY LAND DEVELOPMENT
- 4. THE CONTRACTOR SHALL RETAIN ON THE WORK SITE AT ALL TIMES COPIES OF ALL PERMITS

GENERAL CONSTRUCTION NOTES:

- THERE SHALL BE NO CHANGE OR DEVIATION FROM THESE PLANS UNLESS PRIOR APPROVAL BY THE ENGINEER
- ALL CLEARING AND GRUBBING DEBRIS TO BE BURNED OR REMOVED FROM SITE AND IS PART OF CLEARING AND GRUBBING ITEM
- IT IS THE INTENT OF THE OWNER THAT CERTAIN TREES BE DESIGNATED TO BE SAVED AND PROTECTED BY THE CONTRACTOR. IT IS ASSUMED THESE TREES ARE HEALTHY AND ARE EXPECTED TO BE PART OF THE LANDSCAPE DEVELOPMENT. THEREFORE, IF ANY TREE(S) DAMAGED BY CONSTRUCTION OPERATION OR BY OTHER MEANS (EXCLUDING LIGHTNING, WINDSTORM AND OTHER ACTS OF GOD) PERISHES WITHIN THE CONSTRUCTION PERIOD, IT WILL BE THE RESPONSIBILITY OF THE CONTRACTOR TO REMOVE AND DISPOSE OF THOSE TREES. NO ADDITIONAL COMPENSATION WILL BE MADE BY THE OWNER OR THE LABOR, MATERIAL OR MACHINERY REQUIRED TO REMOVE SAID TREE(S) EXOTIC VEGETATION (E.G. MELALEUCA AND BRAZILIAN PEPPER) EXISTING WITHIN THE PROJECT AREA SHALL BE APPROVED BY THE SARASOTA COUNTY RESOURCE PROTECTION SERVICES.
- WHERE EXCAVATIONS ARE IN CLOSE PROXIMITY OF TREES. THE CONTRACTOR SHALL USE EXTREME CARE IN NOT DAMAGING THE ROOT SYSTEM. NO EQUIPMENT, SUPPLIES OR VEHICLES SHALL BE STORED OR PARKED WITHIN THE DRIP LINE OF TREES TO REMAIN AND BE PRESERVED. IT WILL BE THE RESPONSIBILITY OF THE CONTRACTOR TO INFORM ALL OF HIS EMPLOYEES AND SUBCONTRACTORS OF THIS REQUIREMENT AND TO ENFORCE
- 5. LAY SOD AROUND ALL INLETS, MITERED ENDWALLS, HEADWALLS, SWALES, LAKE SLOPES, AND TWO FEET (2') WIDE STRIP ADJACENT TO ALL CURBING, AND AS DIRECTED BY THE ENGINEER. ALL PROPOSED GROUND ELEVATIONS ARE FINISHED SOD ELEVATIONS. FINISH EARTHWORK GRADING WILL BE 0.2 FEET BELOW ELEVATIONS SHOWN TO ALLOW FOR SOD THICKNESS, SODDING INCLUDES MAINTAINING SLOPES AND SOD UNTIL COMPLETION AND ACCEPTANCE OF TOTAL PROJECT OR GROWTH IS ESTABLISHED WHICHEVER COMES LAST. ALL EROSION SILTATION AND MAINTAINING GRADES IS THE RESPONSIBILITY OF THE
- "CALL SUNSHINE" (1-800-432-4770), COMCAST, FLORIDA POWER & LIGHT CO., SARASOTA COUNTY UTILITIES DEPARTMENT, AND FRONTIER PRIOR TO CONSTRUCTION AND CONNECTION TO EXISTING UTILITIES. IT IS THE CONTRACTOR'S RESPONSIBILITY TO PROTECT EXISTING
- ALL UTILITY LINES, STORM DRAIN LINES AND ACCESSORIES SUCH AS, BUT NOT LIMITED TO: MANHOLES, CLEANOUTS, SEWER AND WATER SERVICES, VALVES, FIRE HYDRANTS AND INLETS WILL BE CONSTRUCTED TO ALIGNMENT AND LOCATIONS SHOWN ON PLANS UNLESS THERWISE DIRECTED BY THE ENGINEER.
- CLEARING, GRUBBING, STRIPPING, AND COMPACTION WILL BE INSPECTED BY THE ENGINEER PRIOR TO FILLING.
- PRIOR TO THE START OF CONSTRUCTION ACTIVITIES, PRESERVE AREAS, EXISTING LAKES & WATERWAYS WITHIN AND ADJOINING THE AREA OF CONSTRUCTION ACTIVITY SHALL BE PROTECTED BY ERECTION OF TREE PROTECTION BARRICADES AND/OR SILT BARRIERS. TREE PROTECTION BARRICADES SHALL MEET THE STANDARDS OF THE SARASOTA COUNTY TREE PROTECTION ORDINANCE. SILT BARRIERS SHALL BE CONSTRUCTED IN ACCORDANCE WITH THE "BEST MANAGEMENT PRACTICES PLAN" AND THE "BMP DETAILS" SHOWN ON DWGS B-1 PROTECTIVE MEASURES TO BE CONSTRUCTED FOR PROTECTION OF PRESERVE AREA SUBJECT TO THE APPROVAL OF THE SARASOTA COUNTY RESOURCE PROTECTION SERVICES. THE RESOURCE PROTECTION SERVICES SHALL BE NOTIFIED WHEN PRESERVE AREA ARRICADES AND BARRIERS ARE IN PLACE.
- 10. THE SITE CONSTRUCTION STAKEOUT SHALL BE PERFORMED UNDER THE DIRECTION OF A FLORIDA REGISTERED SURVEYOR, AUTOCAD FILES WILL BE FURNISHED TO AID IN THE SITE CONSTRUCTION STAKEOUT. ANY DISCREPANCIES FOUND BETWEEN THE AUTOCAD FILES AND SITE CONSTRUCTION PLANS SHALL BE BROUGHT TO THE ENGINEER'S ATTENTION FOR
- 11. ALL DRAINAGE PIPE JOINTS WILL BE WRAPPED PER FDOT STANDARD PLANS INDEX NO.
- 12. ROADWAY AND DRAINAGE STRUCTURES SHALL MEET FDOT STANDARD SPECIFICATIONS SECTION 346 OF 3000 PSI CONCRETE.
- 13. THE WETLAND AND ASSOCIATED UPLAND VEGETATIVE BUFFER SHALL BE MAINTAINED IN ACCORDANCE WITH MANAGEMENT GUIDELINES CONTAINED WITHIN THE COMPREHENSIVE PLAN AS A CONSERVATION AREA OR PRESERVE. ALL ACTIVITIES INVOLVING FILLING, EXCAVATING, WELL DRILLING. ALTERING VEGETATION (INCLUDING TRIMMING OF BOTH TREES AND UNDERSTORY) AND STORING OF MATERIALS SHALL BE PROHIBITED WITHIN THE PRESERVATION AREAS, UNLESS WRITTEN APPROVAL IS FIRST OBTAINED FROM RESOURCE PROTECTION SERVICES TO FACILITATE IMPLEMENTATION OF APPROVED HABITAT MANAGEMENT PLANS OR THE REMOVAL OF NUISANCE/INVASIVE VEGETATION.
- 14. A TREE REMOVAL AND PROTECTION PERMIT WILL BE REQUIRED PRIOR TO ANY CONSTRUCTION, CLEARING OR TREE REMOVAL. ALL WORK PERFORMED SHALL BE ACCORDANCE WITH SARASOTA COUNTY CODE, CHAPTER 54, ARTICLE XVIII.
- 15. EROSION AND SEDIMENT CONTROL BMPS IN ADDITION TO THOSE PRESENTED ON THE PLANS AND OUTLINED IN THE EROSION AND SEDIMENT CONTROL PLAN (ECP), BEST MANAGEMENT PRACTICES (BMP) PLAN, OR STORMWATER POLLUTION PREVENTION PLAN (SWPPP) SHALL BE IMPLEMENTED AS NECESSARY TO PREVENT TURBID DISCHARGES FROM FLOWING ONTO ADJACENT PROPERTIES OR ROADWAYS, OFF SITE STORMWATER CONVEYANCES OR RECEIVING WATERS, OR ON SITE WETLANDS AND SURFACE WATERS. BMPS SHALL BE DESIGNED, INSTALLED, AND MAINTAINED BY THE SITE OPERATOR TO ENSURE THAT OFF SITE SURFACE WATER QUALITY REMAINS CONSISTENT WITH STATE AND LOCAL REGULATIONS. [THE OPERATOR IS THE ENTITY THAT OWNS OR OPERATES THE CONSTRUCTION ACTIVITY AND HAS AUTHORITY TO CONTROL THOSE ACTIVITIES AT THE PROJECT NECESSARY TO ENSURE
- 16. OFFSITE SURFACE WATER DISCHARGES, DISCHARGES TO THE MS4, OR DISCHARGES TO ONSITE WETLANDS OR SURFACE WATERS WITH TURBIDITY IN EXCESS OF 29 NEPHELOMETRIC TURBIDITY UNITS (NTUs) ABOVE BACKGROUND LEVEL SHALL BE IMMEDIATELY CORRECTED. SUCH INCIDENTS SHALL BE REPORTED TO SARASOTA COUNTY WITHIN 24 HOURS OF THE OCCURRENCE (PH: 941.861.5000; EMAIL: REPORTPOLLUTIONOSCGOV.NET). THE REPORT HALL INCLUDE THE CAUSE OF THE DISCHARGE AND CORRECTIVE ACTIONS TAKEN.
- 17. THE OPERATOR SHALL ENSURE THAT ADJACENT PROPERTIES ARE NOT IMPACTED BY WIND EROSION, OR EMISSIONS OF UNCONFINED PARTICULATE MATTER IN ACCORDANCE WITH RULE 62-296.320(4)(C)1, F.A.C., BY TAKING APPROPRIATE MEASURES TO STABILIZE AFFECTED
- 18. FUEL AND OTHER PETROLEUM PRODUCT SPILLS THAT ENTER STORMWATER DRAINS OR WATERBODIES, OR FUEL AND OTHER PETROLEUM PRODUCT SPILLS THAT ARE IN EXCESS OF 25 GALLONS SHALL BE CONTAINED, CLEANED UP, AND IMMEDIATELY REPORTED TO SARASOTA COUNTY (PH: 941.861.5000; EMAIL: REPORTPOLLUTIONOSCGOV.NET). SMALLER GROUND SURFACE SPILLS SHALL BE CLEANED UP AS SOON AS PRACTICAL.

CONSERVATION ENVIRONMENTAL PERMITTING

STANDARD GENERAL COMMENTS

- IMPACTS TO STATE AND FEDERALLY PROTECTED SPECIES AS LISTED IN THE MOST CURRENT VERSION OF "FLORIDA'S ENDANGERED SPECIES, THREATENED SPECIES AND SPECIES OF SPECIAL CONCERN: OFFICIAL LISTS" PREPARED BY THE FLORIDA FISH AND WILDLIFE CONSERVATION COMMISSION (FWC) ARE NOT AUTHORIZED BY THIS PERMIT. THESE SPECIES MAY INCLUDE, BUT ARE NOT LIMITED TO, FLORIDA SCRUB JAY, AMERICAN BALD EAGLE, SHERMAN'S FOX SQUIRREL, BURROWING OWL, GOPHER TORTOISE, GOPHER FROG, AND EASTERN INDIGO SNAKE. PROTECTION EXTENDS TO THE NESTS, BURROWS AND HABITAT UTILIZED BY THESE SPECIES. IF A LISTED SPECIES (OR ITS EVIDENCE, SUCH AS BURROWS, NESTS, SCAT, TRACKS) THAT WAS NOT ADDRESSED IN THIS PERMIT IS OBSERVED PRIOR TO OR DURING CONSTRUCTION, ALL CLEARING AND EARTHMOVING ON-SITE SHALL CEASE. THE PERMITTEE SHALL CONSULT WITH THE FWC REGIONAL OFFICE AND/OR THE U.S. FISH AND WILDLIFE SERVICE REGIONAL OFFICE REGARDING NECESSARY PROTECTION MEASURES AND PROVIDE EVIDENCE OF SUCH CONSULTATION TO RESOURCE PROTECTION SERVICES PRIOR TO RESUMING WORK.
- IF ANY TYPE A FILL (CLEAN EARTHEN MATERIAL) IS TO BE HAULED OFF-SITE, AN EARTHMOVING PERMIT OR LETTER OF EXEMPTION IS REQUIRED FROM RESOURCE PROTECTION SERVICES. IF ANY TYPE A FILL HAULED OFF-SITE IS TO BE STOCKPILED OR FILLED UPON PRIVATE PROPERTIES WITHIN THE UNINCORPORATED AREAS OF SARASOTA COUNTY, THE RECEIVING PROPERTY(S)SHALL POSSESS AUTHORIZATION IN THE FORM OF AN EARTHMOVING PERMIT, A WRITTEN EARTHMOVING EXEMPTION, A BUILDING PERMIT, OR CONSTRUCTION PLAN APPROVAL PRIOR TO RECEIVING SAID FILL. NO TYPE B (CONCRETE, BROKEN ASPHALT, ROCKS), TYPE C (VEGETATIVE LAND CLEARING DEBRIS), OR TYPE D (GARBAGE, REFUSE, WOOD, METAL, PLASTIC, ETC.) FILL MAY BE BURIED WITHIN OR OUTSIDE APPROVED CONSTRUCTION LIMITS. TYPE D FILL MUST BE DISPOSED AT an approved landfill or recycling facility. Type B, C, and D fills generated on—site shall not be stockpiled on—site for GREATER THAN SIX MONTHS. TYPE B, C, AND D FILLS SHALL NOT BE HAULED TO THE SITE FROM OFF-SITE SOURCES. FOR INFORMATION ABOUT EARTHMOVING PERMITS OR EXEMPTIONS, CONTACT ENVIRONMENTAL PERMITTING AT 941—861—5000. IF FILL MATERIAL IS TO BE STOCKPILED WITHIN THE APPROVED CONSTRUCTION LIMITS, THE PROJECT ENGINEER MUST PROVIDE DETAILED DRAWINGS TO LAND DEVELOPMENT

HI HAT RANCH FRUITVILLE BORROW PIT

JULY 2023

CONSTRUCTION PLANS

LOCATED IN SECTIONS 23/24, TOWNSHIP 36S, RANGE 19E SARASOTA COUNTY, FLORIDA

GENERAL CONSTRUCTION NOTES (CONT'D):

- 19. IF PREVIOUSLY UNKNOWN RECOGNIZED ENVIRONMENTAL CONDITIONS (E.G. CONTAMINATED SOIL AND/OR GROUNDWATER, BURIED WASTES, ETC.) ARE DISCOVERED DURING DEVELOPMENT OF THE SITE, ALL ACTIVITY IN THE IMMEDIATE VICINITY SHALL CEASE, AND SARASOTA COUNTY SHALL BE CONTACTED (PH: 941.861.5000; EMAIL: REPORTPOLLUTION@SCGOV.NET).
- 20. PRIOR TO RENOVATION OR DEMOLITION OF EXISTING ON SITE STRUCTURES AN ASBESTOS SURVEY
- 21. FERTILIZER APPLICATION SHALL BE CONSISTENT WITH CHAPTER 54, ARTICLE XXXII (FERTILIZER AND LANDSCAPE MANAGEMENT) OF THE SARASOTA COUNTY CODE.
- 22. NATIONAL POLLUTANT DISCHARGE ELIMINATION SYSTEM STORMWATER:

 I. NPDES CONSTRUCTION GENERIC PERMIT COVERAGE SHALL BE OBTAINED AT LEAST 48 HOURS N ADVANCE OF CONSTRUCTION COMMENCEMENT IN ACCORDANCE WITH THE REQUIREMENTS OF THE NATIONAL POLLUTANT DISCHARGE ELIMINATION SYSTEM (NPDES) GENERIC PERMIT FOR STORMWATER DISCHARGE FROM LARGE AND SMALL CONSTRUCTION ACTIVITIES (AKA. CONSTRUCTION GENERIC PERMIT, OR CGP).

 II. A COPY OF THE CERTIFIED NPDES NOI, OR A COPY OF THE FDEP COVERAGE CONFIRMATION LETTER SHALL BE POSTED AT THE SITE IN ACCORDANCE WITH PART 2.6 OF THE GENERIC PERMIT, AND AS PER SEC 54-187(G)(1) OF THE SARASOTA COUNTY CODE. III. A COPY OF THE CERTIFIED NPDES NOI, OR A COPY OF THE FDEP COVERAGE CONFIRMATION LETTER SHALL BE PROVIDED TO SARASOTA COUNTY WITHIN 7 CALENDAR DAYS IN ACCORDANCE WITH PART 2.6 OF THE GENERIC PERMIT, AND SEC. 54-187(G)(1) OF THE W. THE SWPPP SHALL BE CERTIFIED IN ACCORDANCE WITH PART 4.6 OF THE GENERIC PERMIT, AND A COPY OF THE CERTIFIED DOCUMENT SHALL BE SUBMITTED TO SARASOTA COUNTY AT LEAST 48 HOURS PRIOR TO COMMENCEMENT OF CONSTRUCTION PER SEC 54-187(G)(1) OF V. A COPY OF THE SWPPP, AND COPIES OF THE INSPECTION AND MAINTENANCE RECORDS SHALL BE MAINTAINED AT THE PROJECT SITE, AND SHALL BE READILY AVAILABLE TO COUNTY OR STATE INSPECTORS PER SEC 54-187(G)(1) OF THE SARASOTA COUNTY CODE.
- 23. NATIONAL POLLUTANT DISCHARGE ELIMINATION SYSTEM DEWATERING: IF NOT OTHERWISE COVERED AS OUTLINED UNDER PART 3.4 OF THE GENERIC PERMIT, THE DISCHARGE OF GROUNDWATER PRODUCED THROUGH DEWATERING, TO SURFACE WATERS, OR TO ANY PORTION OF THE MS4 WILL REQUIRE SEPARATE PERMITTING FROM THE FLORIDA DEPARTMENT OF ENVIRONMENTAL PROTECTION (DEP). PERMIT(S) SHALL BE OBTAINED PRIOR TO THE COMMENCEMENT OF DEWATERING. ANALYTICAL RESULTS FROM PRE—DISCHARGE TESTING SHALL BE PROVIDED TO SARASOTA COUNTY PURSUANT TO SECTION 54-185(B) OF THE SARASOTA
- 24. THE CONTRACTOR SHALL ENSURE THAT ADJACENT PROPERTIES ARE NOT IMPACTED BY WIND EROSION OR EMISSIONS OF UNCONFINED PARTICULATE MATTER IN ACCORDANCE WITH RULE 62-296.320(4)(c)1., FLORIDA ADMINISTRATIVE CODE, FROM THE CONSTRUCTION SITE BY TAKING ADEQUATE MEASURES TO STABILIZE AFFECTED AREAS.
- 25. ANY WELLS DISCOVERED ON SITE THAT WILL HAVE NO USE MUST BE PLUGGED BY A LICENSED WELL DRILLING CONTRACTOR IN AN APPROVED MANNER.
- 26. ANY WELL DISCOVERED DURING EARTH MOVING OR EXCAVATION SHALL BE REPORTED TO THE SARASOTA COUNTY HEALTH DEPARTMENT, OFFICE OF ENVIRONMENTAL ENGINEERING WITHIN 24 HOURS AFTER DISCOVERY IS MADE.
- 27. IN THE EVENT THAT THE CONSTRUCTION SITE IS ABANDONED PRIOR TO THE PROJECT COMPLETION, ALL CONSTRUCTION AND VEGETATIVE DEBRIS SHALL BE REMOVED FROM THE SITE
- 28. A SEPARATE BUILDING PERMIT MUST BE APPLIED FOR AND ISSUED FOR EVERY SIGN, WALL. OUTDOOR LIGHTING AND STRUCTURE ON THE SITE. THE APPROVAL OF THESE CONSTRUCTION PLANS DOES NOT EXEMPT THE CONTRACTOR FROM OBTAINING THE NECESSARY BUILDING
- 29. ALKYD THERMOPLASTIC 100 MILS IN THICKNESS AND A MAXIMUM THICKNESS 0.15 INCH OR 150 MILS WHEN MEASURED ABOVE THE PAVEMENT SURFACE. IN ADDITION, ALL CHEVRONS, DIAGONAL AND TRANSVERSE LINES, MESSAGES, SYMBOLS, AND ARROWS, WHEREVER LOCATED, WILL HAVE A THICKNESS OF 0.09 INCH OR 90 MILS TO 0.12 INCH OR 120 MILS WHEN MEASURED ABOVE THE PAVEMENT SURFACE IN ACCORDANCE WITH FDOT SPECIFICATIONS SECTION 701 AND
- 30. THE CONSTRUCTION SITE MUST COMPLY WITH NFPA 1 16.4.3.1.3*, 241: 8.7.2.3, "WATER MAINS AND HYDRANTS SHALL BE COMPLETED AND IN SERVICE (PER PHASE) PRIOR TO COMMENCING VERTICAL CONSTRUCTION ON ANY BUILDING OR BRINGING COMBUSTIBLE STOCK ON SITE." STABLE ROAD SURFACE ACCESS MUST BE PROVIDED AND MAINTAINED TO ALL AREAS OF

OTA COUNTY SUPPLEMENTAL SPECIFICATION SS711.

31. PURSUANT TO ARTICLE 13, SECTION 124-252.g.1.e.5 OF THE SARASOTA COUNTY UDC, DRAINAGE STRUCTURES SHALL BE DESIGNED TO MINIMIZE PONDING WITHIN THE STRUCTURE.

SARASOTA COUNTY FORTUITOUS FINDS STATEMENT:

THE FOLLOWING REQUIREMENTS APPLY TO ALL BUILDING CONSTRUCTION OR ALTERATION, OR LAND ALTERATION ACTIVITIES IN ACCORDANCE WITH

ARTICLE III. CHAPTER 66 (SUB-SECTION 66-81) OF THE SARASOTA

COUNTY CODE AND WITH THE HISTORIC PRESERVATION CHAPTER OF

IF EVIDENCE OF THE EXISTENCE OF HISTORIC RESOURCES IS DISCOVERED OR OBSERVED AT DEVELOPMENT SITES OR DURING DEVELOPMENT ACTIVITIES

AFTER FINAL APPROVAL, ALL WORK SHALL CEASE IN THE AREA OF EFFECT AS DETERMINED BY THE DIRECTOR. THE DEVELOPER, OWNER, CONTRACTOR OR AGENT THEREOF SHALL NOTIFY THE DEPARTMENT OF HISTORICAL

RESOURCES (HISTORY CENTER) WITHIN TWO WORKING DAYS. EXAMPLES OF

STONE TOOLS, SHELL TOOLS, ABORIGINAL OR HISTORIC POTTERY, HISTORIC GLASS, HISTORIC BOTTLES, BONE TOOLS, HISTORIC BUILDING FOUNDATIONS, SHELL MOUNDS, SHELL MIDDENS OR SAND MOUNDS. THE DIRECTOR SHALL

DISCOVERED AT DEVELOPMENT SITES OR DURING DEVELOPMENT ACTIVITY,
ALL WORK IN THE AREA MUST CEASE, AND THE PERMITTEE MUST IMMEDIATELY
NOTIFY THE NEAREST LAW ENFORCEMENT OFFICE AND NOTIFY THE DEPARTMENT
OF HISTORICAL RESOURCES WITHIN TWO WORKING DAYS. ACCORDING TO
CHAPTER 872, FLORIDA STATUTES, IT IS UNLAWFUL TO DISTURB, VANDALIZE
OR DANGE A HIMAN BURNA

EVIDENCE OF HISTORIC RESOURCES INCLUDE WHOLE OR FRAGMENTARY


EFFECTS AS SOON AS POSSIBLE, BUT NOT LATER THAN WITHIN THREE

b. IF ANY HUMAN SKELETAL REMAINS OR ASSOCIATED BURIAL ARTIFACTS ARE

APOXSEE: THE REVISED AND UPDATED SARASOTA COUNTY

WORKING DAYS OF NOTIFICATION

MARKA PARTS

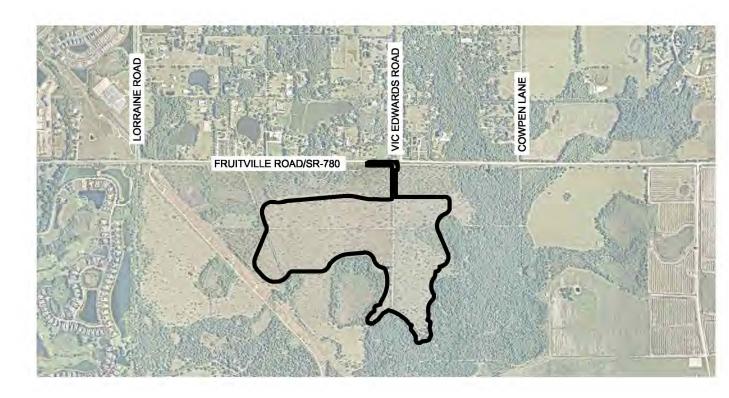

| She | et List Table | | | | |
|--------------|--|--|--|--|--|
| Sheet Number | Sheet Title | | | | |
| A-1 | COVER SHEET | | | | |
| A-2 | GENERAL NOTES | | | | |
| A-3 | EXISTING CONDITIONS PLAN | | | | |
| A-4 | AERIAL SITE PLAN | | | | |
| A-5 | BORING LOCATION PLAN | | | | |
| A-6 | ENVIRONMENTAL INFORMATION | | | | |
| A-7 | HABITAT IMPACT AND COMPENSATION PLAN | | | | |
| B-1 | BEST MANAGEMENT PRACTICES PLAN | | | | |
| B-2 | BEST MANAGEMENT PRACTICES DETAILS | | | | |
| B-3A | RIGHT TURN LANE SIGNAGE AND STRIPING PLAN | | | | |
| B-3B | RIGHT TURN LANE PAVING GRADING AND DRAINAGE PLAN | | | | |
| B-3C | HAUL ROAD PAVING GRADING AND DRAINAGE PLAN | | | | |
| B-4A | ACTIVE EXCAVATION AND DEWATERING PLAN (PHASE 1) | | | | |
| B-4B | ACTIVE EXCAVATION AND DEWATERING PLAN (PHASE 2) | | | | |
| B-5 | CLOSURE PLAN | | | | |
| B-6A | ACTIVE TYPICAL DETAILS AND SECTIONS | | | | |
| B-6B | ACTIVE TYPICAL DETAILS AND SECTIONS | | | | |
| B-6C | ACTIVE TYPICAL DETAILS AND SECTIONS | | | | |
| B-6D | CLOSEOUT TYPICAL DETAILS AND SECTIONS | | | | |
| B-7A | FLOODPLAIN COMPENSATION TYPICAL DETAILS AND SECTIONS | | | | |
| B-7B | FLOODPLAIN COMPENSATION TYPICAL DETAILS AND SECTIONS | | | | |
| 2.2 | | | | | |

HI HAT RANCH, LLLP 11708 FRUITVILLE ROAD SARASOTA, FLORIDA 34240

PHONE: (941) 628-8803

1777 MAIN STREET, SUITE 200 SARASOTA, FLORIDA 34236 PHONE: (941) 379-7600

BRITT SURVEYING, INC. 680 US 41 BYPASS NORTH, SUITE 1 **VENICE, FLORIDA 34285** PHONE: (941) 493-1396 CONTACT: RANDALL E. BRITT, P.L.S.

ENVIRONMENTAL CONSULTANT:

ENVIRONMENTAL CONSULTING & TECHNOLOGY, INC. 1191 SARASOTA CENTER BLVD. SARASOTA, FLORIDA 34240 PHONE: (941) 313-6479 CONTACT: DANA L. WEST

GEOTECHNICAL ENGINEER: ECS FLORIDA, LLC **4524 N. 56TH STREET**

CONTACT: TRAVIS L. GIAFAGLIONE, P.E.

PERMIT NUMBER 22-171896-00-RE

APPLICANT:

KIMLEY-HORN AND ASSOCIATES, INC. CONTACT: WILLIAM E. CONERLY, P.E.

TAMPA, FLORIDA 33610 PHONE: (813) 302-1644

NOTE: IMPROVEMENTS WITHIN SARASOTA COUNTY RIGHT-OF-WAY ARE SHOWN ONLY FOR INFORMATIONAL PURPOSES. RIGHT-OF-WAY IMPROVEMENTS SHALL NOT BE CONSTRUCTED UNTIL SITE AND DEVELOPMENT PLAN APPROVAL.

LAND USE DEVELOPMENT DATA:

0223-00-3000 AND 0225-00-3000 OPEN USE ESTATE 1 - OUE-1

> WEST : OUE-1/PUD EAST : OUE-1 NORTH : OUE-1

TOTAL HI HAT RANCH, LLLP AREA: 155.7 ± ACRES

SOUTH: OUR

CHARACTER AND INTENDED USE STATEMENT:

ESTIMATED VEHICLE TRIPS PER DAY: ±150 TRIPS / DAY

GARBAGE: GARBAGE PICKUP WILL BE PROVIDED BY WASTE MANAGEMENT. ROADWAYS: PRIVATE ROADS WILL BE MAINTAINED BY HI HAT RANCH, LLLP

COMMON AREAS: TO BE MAINTAINED BY HI HAT RANCH, LLLP

EASEMENTS: UTILITY EASEMENTS WILL BE PROVIDED FOR WATER LINES IN ACCORDANCE WITH SARASOTA COUNTY ORDINANCE NO. 2011-044 AND THE SARASOTA COUNTY UDC. LINES WILL BE LOCATED OUTSIDE OF PAVED AREAS WHERE

ACCESS TO THIS PROJECT IS PROVIDED DIRECT FROM FRUITVILLE ROAD (SR 780)

TREE LOCATION: THE PROPOSED DEVELOPMENT AND ITS ORIENTATION TO THE EXISTING TREES IS SHOWN ON THE AERIAL SITE PLAN. TREES WILL BE PRESERVED WHERE POSSIBLE. TREE REMOVAL PERMIT WILL BE APPLIED FOR

PRACTICAL DRAINAGE EASEMENTS ARE DESIGNATED ON THE PLAN.

PRIOR TO CONSTRUCTION.

NOTE: SITE IS LOCATED WITHIN FLOOD ZONE X PER FEMA PANEL NO. 12115C0160F AND 12115C0180F

ENVIRONMENTAL AND SURFACE WATER MANAGEMENT SYSTEM:

DRAINAGE SYSTEM WILL BE MAINTAINED BY HI HAT RANCH, LLLP STATEMENT OF OWNERSHIP AND UNIFIED CONTROL

HI HAT RANCH, LLLP 11708 FRUITVILLE ROAD

SARASOTA, FLORIDA 34240

PHONE: (941) 628-8803 "COMMON AREAS" INCLUDING, BUT NOT LIMITED TO, PRIVATE RECREATION AREAS, OPEN

SPACE AND LANDSCAPED AREAS, DRAINAGE AREAS, LAKES, ROADWAYS, SANCTUARIES AND ENTRANCEWAYS SHALL REMAIN UNDER THE UNIFIED OWNERSHIP AND CONTROL OF

ACTION PLAN SHOULD EXCESSIVE WETLAND

DRAWDOWN OCCUR:

STEP 1: CLEANOUT RECHARGE DITCHES TO REMOVE SILT BUILDUP UNTIL DRAWDOWN

IMPACTS SUBSIDE STEP 2: RECONFIGURE OR RESIZE RECHARGE DITCHES UNTIL DRAWDOWN IMPACTS

STEP 3: CEASE ALL DEWATERING ACTIVITIES UNTIL ACCEPTABLE SOLUTION IS

SURVEY NOTE:
ELEVATIONS SHOWN HEREON REFER TO NGS BENCH MARK # GOODRICH AZ RESET PUBLISHED ELEVATION =33.44 FEET (NAVD 88). ALL COORDINATES SHOWN HEREON ARE GRID, FLORIDA STATE PLANE COORDINATE SYSTEM (FLORIDA WEST ZONE) (NAD83), USING FLORIDA PERMANENT REFERENCE NETWORK BASE STATION FRUT (FRUITVILLE).

ENVIRONMENTAL PROTECTION DIVISION NOTE:
IMPACTS TO STATE AND FEDERALLY PROTECTED SPECIES AS LISTED IN THE MOST CURRENT VERSION OF "FLORIDA'S ENDANGERED SPECIES, THREATENED SPECIES AND SPECIES OF SPECIAL CONCERN: OFFICIAL LISTS" PREPARED BY THE FLORIDA FISH AND WILDLIFE CONSERVATION COMMISSION (FWC) ARE NOT AUTHORIZED BY THIS PERMIT. THESE SPECIES MAY INCLUDE, BUT ARE NOT LIMITED TO, FLORIDA SCRUB JAY, AMERICAN BALD EAGLE, SHERMAN'S FOX SQUIRREL, BURROWING OWL, GOPHER TORTOISE, GOPHER FROG, AND EASTERN INDIGO SNAKE. PROTECTION EXTENDS TO THE NESTS, BURROWS AND HABITAT UTILIZED BY THESE SPECIES. IF A listed species (or its evidence, such as burrows, nests, scat, tracks) that was not addressed in this permit is deserved prior to or during CONSTRUCTION, ALL CLEARING AND EARTHMOVING ON—SITE SHALL CEASE. THE PERMITTEE SHALL CONSULT WITH THE FWC REGIONAL OFFICE AND/OR THE U.S. FISH AND WILDLIFE SERVICE REGIONAL OFFICE REGARDING NECESSARY PROTECTION MEASURES AND PROVIDE EVIDENCE OF SUCH CONSULTATION TO THE ENVIRONMENTAL PROTECTION DIVISION PRIOR TO RESUMING WORK.

FLORIDA POWER & LIGHT

5657 NORTH McINTOSH ROAD

SARASOTA, FLORIDA 34233

UTILITY COMPANIES:

SARASOTA COUNTY UTILITIES 1761 12TH ST SARASOTA, FLORIDA 34236

FRONTIER COMMUNICATIONS COMCAST CABLE 1617 U.S. 41 BYPASS S 529 CLUBSIDE CIRCLE VENICE, FLORIDA 34293 VENICE, FLORIDA 34293

I HEREBY CERTIFY THAT TO THE BEST OF MY KNOWLEDGE AND BELIEF THE DESIGN OF THIS PROJECT, AS PREPARED UNDER MY PERSONAL DIRECTION AND CONTROL, COMPLIES WITH ALL APPLICABLE STANDARDS, INCLUDING THE "MANUAL OF UNIFORM MINIMUM STANDARDS FOR DESIGN, CONSTRUCTION AND MAINTENANCE FOR STREETS AND HIGHWAYS" AS ADOPTED BY THE FLORIDA DEPARTMENT OF TRANSPORTATION PURSUANT TO SUBSECTIONS 335.075(1) AND (4), FLORIDA STATUTES AND THE SARASOTA COUNTY UDC.

THIS ITEM HAS BEEN DIGITALLY SIGNED AND SEALED BY WILLIAM E. CONERLY, P.E. ON THE DATE ADJACENT TO THE SEAL. PRINTED COPIES OF THIS DOCUMENT ARE NOT CONSIDERED SIGNED AND SEALED AND THE SIGNATURE MUST BE VERIFIED ON ANY ELECTRONIC COPIES.

CALL 2 WORKING DAYS BEFORE YOU DIG IT'S THE LAW! Know what's below.

SUNSHINE STATE ONE CALL OF FLORIDA, INC.

Call before you d

THE SITE CONSTRUCTION STAKEOUT SHALL BE PERFORMED UNDER THE DIRECTION OF A FLORIDA REGISTERED SURVEYOR. AUTOCAD FILES WILL BE FURNISHED TO AID IN THE SITE CONSTRUCTION STAKEOUT. ANY DISCREPANCIES FOUND BETWEEN THE AUTOCAD FILES AND SITE CONSTRUCTION

PLANS SHALL BE BROUGHT TO THE ENGINEER'S ATTENTION FOR CLARIFICATION PRIOR TO THAT

(C) 2023 KIMLEY-HORN AND ASSOCIATES, INC.

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DETAILS

WETLAND MONITORING PLAN

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GENERAL CONSTRUCTION NOTES

- THE CONTRACTOR AND SUBCONTRACTORS SHALL OBTAIN A COPY OF THE FLORIDA DEPARTMENT OF TRANSPORTATION "STANDARD SPECIFICATIONS FOR ROAD AND BRIDGE CONSTRUCTION" (LATEST EDITION) AND BECOME FAMILIAR WITH THE CONTENTS PRIOR TO COMMENCING WORK, AND, UNLESS OTHERWISE NOTED, ALL WORK SHALL CONFORM AS APPLICABLE TO THESE STANDARDS AND
- 2. THE CONTRACTOR SHALL BE RESPONSIBLE FOR FURNISHING ALL MATERIAL AND LABOR TO CONSTRUCT THE FACILITY AS SHOWN AND DESCRIBED IN THE CONSTRUCTION DOCUMENTS IN ACCORDANCE WITH THE APPROPRIATE APPROVING AUTHORITIES, SPECIFICATIONS AND REQUIREMENTS. CONTRACTOR SHALL CLEAR AND GRUB ALL AREAS UNLESS OTHERWISE INDICATED, REMOVING TREES, STUMPS, ROOTS, MUCK, EXISTING PAVEMENT AND ALL OTHER DELETERIOUS MATERIAL.
- 3. EXISTING UTILITIES SHOWN ARE LOCATED ACCORDING TO THE INFORMATION AVAILABLE TO THE ENGINEER AT THE TIME OF THE TOPOGRAPHIC SURVEY AND HAVE NOT BEEN INDEPENDENTLY VERIFIED BY THE OWNER OR THE ENGINEER. GUARANTEE IS NOT MADE THAT ALL EXISTING UNDERGROUND UTILITIES ARE SHOWN OR THAT THE LOCATION OF THOSE SHOWN ARE ENTIRELY ACCURATE, FINDING THE ACTUAL LOCATION OF ANY EXISTING UTILITIES IS THE CONTRACTOR'S RESPONSIBILITY AND SHALL BE DONE BEFORE HE COMMENCES ANY WORK IN THE VICINITY. FURTHERMORE, THE CONTRACTOR SHALL BE FULLY RESPONSIBLE FOR ANY AND ALL DAMAGES DUE TO THE CONTRACTOR'S FAILURE TO EXACTLY LOCATE AND PRESERVE ANY AND ALL UNDERGROUND UTILITIES. THE OWNER OR ENGINEER WILL ASSUME NO LIABILITY FOR ANY DAMAGES SUSTAINED OR COST INCURRED BECAUSE OF THE OPERATIONS IN THE VICINITY OF EXISTING UTILITIES OR STRUCTURES, NOR FOR TEMPORARY BRACING AND SHORING OF SAME. IF IT IS NECESSARY TO SHORE, BRACE, SWING OR RELOCATE A UTILITY, THE UTILITY COMPANY OR DEPARTMENT AFFECTED SHALL BE CONTACTED AND THEIR PERMISSION OBTAINED REGARDING THE METHOD TO USE FOR SUCH WORK.
- 4. IT IS THE CONTRACTOR'S RESPONSIBILITY TO CONTACT THE VARIOUS UTILITY COMPANIES WHICH MAY HAVE BURIED OR AERIAL UTILITIES WITHIN OR NEAR THE CONSTRUCTION AREA BEFORE COMMENCING WORK. THE CONTRACTOR SHALL PROVIDE 48 HOURS MINIMUM NOTICE TO ALL UTILITY COMPANIES PRIOR TO BEGINNING CONSTRUCTION. A LIST OF THE UTILITY COMPANIES WHICH THE CONTRACTOR MUST CALL BEFORE COMMENCING WORK IS PROVIDED ON THE COVER SHEET OF THESE CONSTRUCTION PLANS. THIS LIST SERVES AS A GUIDE ONLY AND IS NOT INTENDED TO LIMIT THE UTILITY COMPANIES WHICH THE CONTRACTOR MAY WISH TO NOTIFY.
- 5. THE CONTRACTOR SHALL BE RESPONSIBLE FOR OBTAINING ALL REQUIRED CONSTRUCTION PERMITS AND BONDS IF REQUIRED PRIOR TO CONSTRUCTION.
- 6. THE CONTRACTOR SHALL HAVE AVAILABLE AT THE JOB SITE AT ALL TIMES ONE COPY OF THE CONSTRUCTION DOCUMENTS INCLUDING PLANS, SPECIFICATIONS, AND SPECIAL CONDITIONS AND COPIES OF ANY REQUIRED CONSTRUCTION PERMITS.
- ANY DISCREPANCIES ON THE DRAWINGS SHALL BE IMMEDIATELY BROUGHT TO THE ATTENTION OF THE OWNER AND ENGINEER BEFORE COMMENCING WORK. NO FIELD CHANGES OR DEVIATIONS FROM DESIGN ARE TO BE MADE WITHOUT PRIOR APPROVAL OF THE OWNER AND NOTIFICATION TO THE ENGINEER.
- ALL COPIES OF COMPACTION, CONCRETE AND OTHER REQUIRED TEST RESULTS ARE TO BE SENT TO THE OWNER AND DESIGN ENGINEER OF RECORD DIRECTLY FROM THE TESTING AGENCY.
- THE CONTRACTOR SHALL BE RESPONSIBLE FOR SUBMITTING TO THE ENGINEER A CERTIFIED RECORD SURVEY SIGNED AND SEALED BY A PROFESSIONAL LAND SURVEYOR REGISTERED IN THE STATE OF FLORIDA DEPICTING THE ACTUAL FIELD LOCATION OF ALL CONSTRUCTED IMPROVEMENTS THAT ARE REQUIRED BY THE JURISDICTIONAL AGENCIES FOR THE CERTIFICATION PROCESS. ALL SURVEY COSTS WILL BE THE CONTRACTORS RESPONSIBILITY.
- 10. THE CONTRACTOR SHALL BE RESPONSIBLE FOR DOCUMENTING AND MAINTAINING AS-BUILT INFORMATION WHICH SHALL BE RECORDED AS CONSTRUCTION PROGRESSES OR AT THE COMPLETION OF APPROPRIATE CONSTRUCTION INTERVALS AND SHALL BE RESPONSIBLE FOR PROVIDING AS-BUILT DRAWINGS TO THE OWNER FOR THE PURPOSE OF CERTIFICATION TO JURISDICTIONAL AGENCIES AS REQUIRED. ALL AS-BUILT DATA SHALL BE COLLECTED BY A STATE OF FLORIDA PROFESSIONAL LAND SURVEYOR WHOSE SERVICES ARE ENGAGED BY THE CONTRACTOR.
- 11. ANY WELLS DISCOVERED ON SITE THAT WILL HAVE NO USE MUST BE PLUGGED BY A LICENSED WELL DRILLING CONTRACTOR IN A MANNER APPROVED BY ALL JURISDICTIONAL AGENCIES. CONTRACTOR SHALL BE RESPONSIBLE FOR OBTAINING ANY WELL ABANDONMENT PERMITS REQUIRED.
- 12. ANY WELL DISCOVERED DURING EARTH MOVING OR EXCAVATION SHALL BE REPORTED TO THE APPROPRIATE JURISDICTIONAL AGENCIES WITHIN 24 HOURS AFTER DISCOVERY IS MADE.
- 13. THE CONTRACTOR SHALL BE RESPONSIBLE FOR VERIFYING THAT THE PROPOSED IMPROVEMENTS SHOWN ON THE PLANS DO NOT CONFLICT WITH ANY KNOWN EXISTING OR OTHER PROPOSED IMPROVEMENTS. IF ANY CONFLICTS ARE DISCOVERED, THE CONTRACTOR SHALL NOTIFY THE OWNER PRIOR TO INSTALLATION OF ANY PORTION OF THE SITE WORK THAT WOULD BE AFFECTED. FAILURE TO NOTIFY OWNER OF AN IDENTIFIABLE CONFLICT PRIOR TO PROCEEDING WITH INSTALLATION RELIEVES OWNER OF ANY OBLIGATION TO PAY FOR A RELATED CHANGE ORDER.
- 14. AUXILIARY TURN LANE WILL BE DESIGNED AND CONSTRUCTED CONSISTENT WITH FDOT'S ROADWAY AND TRAFFIC DESIGN STANDARDS INDEXES 301 AND 526 CONSISTENT WITH STIPULATION NO. 22 AND 23 OF ORDINANCE NO. 2015-025.
- 15. ALL SIDEWALKS, CURB RAMPS, BUILDING ENTRY WALKWAYS, HANDICAP ACCESSIBLE PARKING SHALL COMPLY WITH AMERICAN WITH DISABILITIES ACT.
- 16. THE WETLANDS, MITIGATION AREAS, AND ASSOCIATED UPLAND VEGETATIVE BUFFERS SHALL BE MAINTAINED IN ACCORDANCE WITH MANAGEMENT GUIDELINES CONTAINED WITHIN THE COMPREHENSIVE PLAN AS A PRESERVE AND LABELED A PRESERVE ON ALL PLANS. ALL ACTIVITIES INCLUDING BUT NOT LIMITED TO FILLING, EXCAVATING, WELL DRILLING, ALTERING VEGETATION (INCLUDING TRIMMING OF BOTH TREES AND UNDERSTORY) AND STORING OF MATERIALS SHALL BE PROHIBITED WITHIN PRESERVATION AREAS, UNLESS WRITTEN APPROVAL IS FIRST OBTAINED FROM RESOURCE PROTECTION SERVICES. EXCEPTION MAY BE GRANTED BY RESOURCE PROTECTION SERVICES TO FACILITATE IMPLEMENTATION OF APPROVED HABITAT MANAGEMENT PLANS OR THE HAND REMOVAL OF NUISANCE/INVASIVE VEGETATION.
- 17. FIRE HYDRANTS MUST BE INSTALLED AND ACTIVATED PRIOR TO COMBUSTIBLE CONSTRUCTION MATERIAL ARRIVING ON SITE. STABLE ROAD SURFACE ACCESS MUST BE PROVIDED TO ALL AREAS OF CONSTRUCTION FOR EMERGENCY VEHICLES.
- 18. NO CLEARING WITH HEAVY EQUIPMENT, FILLING OR PLACEMENT OF IMPROVEMENTS OR UTILITY LINES SHALL OCCUR WITHIN THE PROTECTED ROOT ZONE OF ANY CANOPY TREE TO BE SAVED, PER SECTION 54-588 (1)(B) OF SARASOTA COUNTY CODE. THE PROTECTED ROOT ZONE IS DEFINED AS THE DRIPLINE OF THE TREE. ONLY HAND CLEARING OR MOWING IS PERMITTED WITHIN THE PROTECTED ROOT ZONE OF CANOPY TREES TO BE SAVED IF AUTHORIZED BY THE ADMINISTRATOR. WHERE UNAUTHORIZED REMOVAL OF NATIVE VEGETATION WITHIN THE PROTECTED ROOT ZONE OCCURS THE ADMINISTRATOR MAY REQUIRE THE REPLANTING OF UNDERSTORY VEGETATION. FULL DRIPLINE PROTECTION IS REQUIRED; HOWEVER, THE ADMINISTRATOR MAY ALLOW CERTAIN ACTIVITIES TO BE CONDUCTED WITHIN THE BARRICADED DRIPLINE OF A TREE, SO LONG AS THE COUNTY DETERMINES THAT THE TREE WILL NOT BE ADVERSELY AFFECTED.

DEMOLITION NOTES

- 1. ALL MATERIAL REMOVED FROM THIS SITE BY THE CONTRACTOR SHALL BE DISPOSED OF BY THE CONTRACTOR IN A LEGAL MANNER.
- 2. REFER TO THE TOPOGRAPHIC SURVEY FOR ADDITIONAL DETAILS OF EXISTING STRUCTURES, ETC., LOCATED WITHIN THE PROJECT SITE. UNLESS OTHERWISE NOTED, ALL EXISTING BUILDINGS, STRUCTURES, SLABS, CONCRETE, ASPHALT, DEBRIS PILES, SIGNS, AND ALL APPURTENANCES ARE TO BE REMOVED FROM THE SITE BY THE CONTRACTOR AND PROPERLY DISPOSED OF IN A LEGAL MANNER AS PART OF THIS CONTRACT. SOME ITEMS TO BE REMOVED MAY NOT BE DEPICTED ON THE TOPOGRAPHIC SURVEY. IT IS THE CONTRACTOR'S RESPONSIBILITY TO VISIT THE SITE AND DETERMINE THE FULL EXTENT OF ITEMS TO BE REMOVED. IF ANY ITEMS ARE IN QUESTION, THE CONTRACTOR SHALL CONTACT THE OWNER PRIOR TO REMOVAL OF SAID ITEMS.
- 3. THE CONTRACTOR SHALL REFER TO THE DEMOLITION PLAN FOR DEMOLITION/PRESERVATION OF EXISTING TREES. ALL TREES NOT SPECIFICALLY SHOWN TO BE PRESERVED OR RELOCATED SHALL BE REMOVED AS A PART OF THIS CONTRACT. TREE PROTECTION FENCING SHALL BE INSTALLED PRIOR TO ANY DEMOLITION.

PAVING, GRADING AND DRAINAGE NOTES

- 1. ALL PAVING, CONSTRUCTION, MATERIALS, AND WORKMANSHIP WITHIN COUNTY'S RIGHT-OF-WAY SHALL BE IN ACCORDANCE WITH LOCAL OR COUNTY SPECIFICATIONS AND STANDARDS (LATEST EDITION) OR FDOT SPECIFICATIONS AND STANDARDS (LATEST EDITION) IF NOT COVERED BY LOCAL OR COUNTY REGULATIONS.
- 2. ALL UNPAVED AREAS IN EXISTING RIGHTS-OF-WAY DISTURBED BY CONSTRUCTION SHALL BE REGRADED AND SODDED.
- 3. TRAFFIC CONTROL ON ALL FDOT, LOCAL AND COUNTY RIGHTS-OF-WAY SHALL MEET THE REQUIREMENTS OF THE MANUAL OF UNIFORM TRAFFIC CONTROL DEVICES (U.S. DOT/FHA) AND THE REQUIREMENTS OF THE STATE AND ANY LOCAL AGENCY HAVING JURISDICTION. IN THE EVENT THAT THE CONTRACT DOCUMENTS AND THE JURISDICTIONAL AGENCY REQUIREMENTS ARE NOT IN AGREEMENT, THE MOST STRINGENT SHALL GOVERN. ALL ROADS OPEN TO PUBLIC TRAVEL, WHETHER PUBLIC OR PRIVATE, ARE SUBJECT TO THE MUTCD.
- 4. THE CONTRACTOR SHALL GRADE THE SITE TO THE ELEVATIONS INDICATED AND SHALL REGRADE WASHOUTS WHERE THEY OCCUR AFTER EVERY RAINFALL UNTIL A GRASS STAND IS WELL ESTABLISHED OR ADEQUATE STABILIZATION OCCURS.
- 5. ALL OPEN AREAS WITHIN THE PROJECT SITE SHALL BE SODDED UNLESS INDICATED OTHERWISE ON THE LANDSCAPE PLAN.
- 6. ALL AREAS INDICATED AS PAVEMENT SHALL BE CONSTRUCTED IN ACCORDANCE WITH THE TYPICAL PAVEMENT SECTIONS AS INDICATED ON THE DRAWINGS.
- 7. WHERE EXISTING PAVEMENT IS INDICATED TO BE REMOVED AND REPLACED, THE CONTRACTOR SHALL SAW CUT A MINIMUM 2" DEEP FOR A SMOOTH AND STRAIGHT JOINT AND REPLACE THE PAVEMENT WITH THE SAME TYPE AND DEPTH OF MATERIAL AS EXISTING OR AS INDICATED.
- 8. WHERE NEW PAVEMENT MEETS THE EXISTING PAVEMENT, THE CONTRACTOR SHALL SAW CUT THE EXISTING PAVEMENT A MINIMUM 2" DEEP FOR A SMOOTH AND STRAIGHT JOINT AND MATCH THE EXISTING PAVEMENT ELEVATION WITH THE PROPOSED PAVEMENT UNLESS OTHERWISE INDICATED.
- 9. THE CONTRACTOR SHALL INSTALL FILTER FABRIC OVER ALL DRAINAGE STRUCTURES FOR THE DURATION OF CONSTRUCTION AND UNTIL ACCEPTANCE OF THE PROJECT BY THE OWNER. ALL DRAINAGE STRUCTURES SHALL BE CLEANED OF DEBRIS AS REQUIRED DURING AND AT THE END OF CONSTRUCTION TO PROVIDE POSITIVE DRAINAGE FLOWS.
- 10. IF DEWATERING IS REQUIRED, THE CONTRACTOR SHALL OBTAIN ANY APPLICABLE REQUIRED PERMITS. THE CONTRACTOR IS TO COORDINATE WITH THE OWNER AND THE DESIGN ENGINEER PRIOR TO ANY EXCAVATION.
- 11. STRIP TOPSOIL AND ORGANIC MATTER FROM ALL AREAS OF THE SITE AS REQUIRED. IN SOME CASES TOPSOIL MAY BE STOCKPILED ON SITE FOR PLACEMENT WITHIN LANDSCAPED AREAS BUT ONLY AS DIRECTED BY THE OWNER.
- 12. FIELD DENSITY TESTS SHALL BE TAKEN AT INTERVALS IN ACCORDANCE WITH THE LOCAL JURISDICTIONAL AGENCY OR TO FDOT STANDARDS. IN THE EVENT THAT THE CONTRACT DOCUMENTS AND THE JURISDICTIONAL AGENCY REQUIREMENTS ARE NOT IN AGREEMENT, THE MOST STRINGENT SHALL GOVERN.
- 13. ALL SLOPES AND AREAS DISTURBED BY CONSTRUCTION SHALL BE GRADED AS PER PLANS. THE AREAS SHALL THEN BE SODDED OR SEEDED AS SPECIFIED IN THE PLANS, FERTILIZED, MULCHED, WATERED AND MAINTAINED UNTIL HARDY GRASS GROWTH IS ESTABLISHED IN ALL AREAS. ANY AREAS DISTURBED FOR ANY REASON PRIOR TO FINAL ACCEPTANCE OF THE JOB SHALL BE CORRECTED BY THE CONTRACTOR AT NO ADDITIONAL COST TO THE OWNER. ALL EARTHEN AREAS WILL BE SODDED OR SEEDED AND MULCHED AS SHOWN ON THE LANDSCAPING PLAN.
- 14. ALL CUT OR FILL SLOPES SHALL BE 4 (HORIZONTAL) :1 (VERTICAL) OR FLATTER UNLESS OTHERWISE
- 15. THE CONTRACTOR SHALL BE RESPONSIBLE FOR THE CONTROL OF DUST AND DIRT RISING AND SCATTERING IN THE AIR DURING CONSTRUCTION AND SHALL PROVIDE WATER SPRINKLING OR OTHER SUITABLE METHODS OF CONTROL. THE CONTRACTOR SHALL COMPLY WITH ALL GOVERNING REGULATIONS PERTAINING TO ENVIRONMENTAL PROTECTION.
- 16. THE CONTRACTOR SHALL TAKE ALL REQUIRED MEASURES TO CONTROL TURBIDITY, INCLUDING BUT NOT LIMITED TO THE INSTALLATION OF TURBIDITY BARRIERS AT ALL LOCATIONS WHERE THE POSSIBILITY OF TRANSFERRING SUSPENDED SOLIDS INTO THE RECEIVING WATER BODY EXISTS DUE TO THE PROPOSED WORK. TURBIDITY BARRIERS MUST BE MAINTAINED IN EFFECTIVE CONDITION AT ALL LOCATIONS UNTIL CONSTRUCTION IS COMPLETED AND DISTURBED SOIL AREAS ARE STABILIZED. THEREAFTER, THE CONTRACTOR MUST REMOVE THE BARRIERS. AT NO TIME SHALL THERE BE ANY OFF-SITE DISCHARGE WHICH VIOLATES THE WATER QUALITY STANDARDS IN CHAPTER 17-302, FLORIDA ADMINISTRATIVE CODE.
- 17. SOD, WHERE CALLED FOR, MUST BE INSTALLED AND MAINTAINED ON EXPOSED SLOPES WITHIN 48 HOURS OF COMPLETING FINAL GRADING, AND AT ANY OTHER TIME AS NECESSARY, TO PREVENT EROSION, SEDIMENTATION OR TURBID DISCHARGES.
- 18. THE CONTRACTOR MUST REVIEW AND MAINTAIN A COPY OF THE ENVIRONMENTAL RESOURCE PERMIT COMPLETE WITH ALL CONDITIONS, ATTACHMENTS, EXHIBITS, AND PERMIT MODIFICATIONS IN GOOD CONDITION AT THE CONSTRUCTION SITE. THE COMPLETE PERMIT MUST BE AVAILABLE FOR REVIEW UPON REQUEST BY WATER MANAGEMENT DISTRICT REPRESENTATIVES.
- 19. THE CONTRACTOR SHALL ENSURE THAT ISLAND PLANTING AREAS AND OTHER PLANTING AREAS ARE NOT COMPACTED AND DO NOT CONTAIN ROAD BASE MATERIALS. THE CONTRACTOR SHALL ALSO EXCAVATE AND REMOVE ALL UNDESIRABLE MATERIAL FROM ALL AREAS ON THE SITE TO BE PLANTED AND PROPERLY DISPOSED OF IN A LEGAL MANNER.
- 20. THE CONTRACTOR SHALL INSTALL ALL UNDERGROUND STORM WATER PIPING PER MANUFACTURER'S RECOMMENDATIONS.
- 21. ROADWAY AND DRAINAGE STRUCTURES CONCRETE SHALL MEET FDOT STANDARD SPECIFICATIONS SECTION 346 OF 3000 PSI.
- 22. ALL DRAINAGE CULVERT JOINTS SHALL BE WRAPPED PER FDOT INDEX 280.

MAINTENANCE

- ALL MEASURES STATED ON THE EROSION AND SEDIMENT CONTROL PLAN, AND IN THE STORM WATER POLLUTION PREVENTION PLAN, SHALL BE MAINTAINED IN FULLY FUNCTIONAL CONDITION UNTIL NO LONGER REQUIRED FOR A COMPLETED PHASE OF WORK OR FINAL STABILIZATION OF THE SITE. ALL EROSION AND SEDIMENTATION CONTROL MEASURES SHALL BE CHECKED BY A QUALIFIED PERSON AT LEAST ONCE EVERY SEVEN CALENDAR DAYS AND WITHIN 24 HOURS OF THE END OF A 0.5" RAINFALL EVENT, AND CLEANED AND REPAIRED IN ACCORDANCE WITH THE FOLLOWING:
- INLET PROTECTION DEVICES AND BARRIERS SHALL BE REPAIRED OR REPLACED IF THEY SHOW SIGNS OF UNDERMINING, OR DETERIORATION.
- 2. ALL SEEDED AREAS SHALL BE CHECKED REGULARLY TO SEE THAT A GOOD STAND IS MAINTAINED. AREAS SHOULD BE FERTILIZED, WATERED AND RESEEDED AS NEEDED. FOR MAINTENANCE REQUIREMENTS REFER TO SECTION 981 OF THE STANDARD SPECIFICATIONS.
- 3. SILT FENCES SHALL BE REPAIRED TO THEIR ORIGINAL CONDITIONS IF DAMAGED. SEDIMENT SHALL BE REMOVED FROM THE SILT FENCES WHEN IT REACHES ONE-HALF THE HEIGHT OF THE SILT FENCE.
- 4. THE CONSTRUCTION ENTRANCES SHALL BE MAINTAINED IN A CONDITION WHICH WILL PREVENT TRACKING OR FLOW OF MUD ONTO PUBLIC RIGHTS-OF-WAY. THIS MAY REQUIRE PERIODIC TOP DRESSING OF THE CONSTRUCTION ENTRANCES AS CONDITIONS DEMAND.
- 5. THE TEMPORARY PARKING AND STORAGE AREA SHALL BE KEPT IN GOOD CONDITION (SUITABLE FOR PARKING AND STORAGE). THIS MAY REQUIRE PERIODIC TOP DRESSING OF THE TEMPORARY PARKING AS CONDITIONS DEMAND.
- 6. OUTLET STRUCTURES IN THE SEDIMENTATION BASINS SHALL BE MAINTAINED IN OPERATIONAL CONDITIONS AT ALL TIMES. SEDIMENT SHALL BE REMOVED FROM SEDIMENT BASINS OR TRAPS WHEN THE DESIGN CAPACITY HAS BEEN REDUCED BY 55 CUBIC YARDS / ACRE.
- 7. ALL MAINTENANCE OPERATIONS SHALL BE DONE IN A TIMELY MANNER BUT IN NO CASE LATER THAN 2 CALENDAR DAYS FOLLOWING THE INSPECTION.

POLLUTION PREVENTION NOTES

DISCHARGE AND CORRECTIVE ACTIONS TAKEN.

- a. EROSION AND SEDIMENT CONTROL BMPS IN ADDITION TO THOSE PRESENTED ON THE PLANS AND OUTLINED IN THE EROSION AND SEDIMENT CONTROL PLAN (ECP), BEST MANAGEMENT PRACTICES (BMP) PLAN, OR STORMWATER POLLUTION PREVENTION PLAN (SWPPP) SHALL BE IMPLEMENTED AS NECESSARY TO PREVENT TURBID DISCHARGES FROM FLOWING ONTO ADJACENT PROPERTIES OR ROADWAYS, OFF SITE STORMWATER CONVEYANCES OR RECEIVING WATERS, OR ON SITE WETLANDS AND SURFACE WATERS. BMPS SHALL BE DESIGNED, INSTALLED, AND MAINTAINED BY THE SITE OPERATOR TO ENSURE THAT OFF SITE SURFACE WATER QUALITY REMAINS CONSISTENT WITH STATE AND LOCAL REGULATIONS. THE OPERATOR IS THE ENTITY THAT OWNS OR OPERATES THE CONSTRUCTION ACTIVITY AND HAS AUTHORITY TO CONTROL THOSE ACTIVITIES AT THE PROJECT NECESSARY TO ENSURE COMPLIANCE.]
- b. OFF SITE SURFACE WATER DISCHARGES, DISCHARGES TO THE MS4, OR DISCHARGES TO ONSITE WETLANDS OR SURFACE WATERS WITH TURBIDITY IN EXCESS OF 29 NEPHELOMETRIC TURBIDITY UNITS (NTUS) ABOVE BACKGROUND LEVEL SHALL BE WITHIN 24 HOURS OF THE OCCURRENCE (PH: 941.861.5000; EMAIL: REPORTPOLLUTION@SCGOV.NET). THE REPORT SHALL INCLUDE THE CAUSE OF THE
- THE OPERATOR SHALL ENSURE THAT ADJACENT PROPERTIES ARE NOT IMPACTED BY WIND EROSION, OR EMISSIONS OF UNCONFINED PARTICULATE MATTER IN ACCORDANCE WITH
- d. FUEL AND OTHER PETROLEUM PRODUCT SPILLS THAT ENTER STORMWATER DRAINS OR 25 GALLONS SHALL BE CONTAINED, CLEANED UP, AND IMMEDIATELY REPORTED TO SARASOTA COUNTY (PH: 941.861.5000; EMAIL: REPORTPOLLUTION@SCGOV.NET). SMALLER GROUND SURFACE SPILLS SHALL BE CLEANED UP AS SOON AS PRACTICAL.
- e. IF PREVIOUSLY UNKNOWN RECOGNIZED ENVIRONMENTAL CONDITIONS (E.G. CONTAMINATED SOIL AND/OR GROUNDWATER, BURIED WASTES, ETC.) ARE DISCOVERED DURING DEVELOPMENT OF THE SITE, ALL ACTIVITY IN THE IMMEDIATE VICINITY SHALL CEASE, AND SARASOTA COUNTY SHALL BE CONTACTED (PH: 941.861.5000; EMAIL: REPORTPOLLUTION@SCGOV.NET).
- f. PRIOR TO RENOVATION OR DEMOLITION OF EXISTING ON SITE STRUCTURES AN ASBESTOS SURVEY AND/OR ASBESTOS NOTIFICATION MAY BE REQUIRED.
- (FERTILIZER AND LANDSCAPE MANAGEMENT) OF THE SARASOTA COUNTY CODE.
- h. NATIONAL POLLUTANT DISCHARGE ELIMINATION SYSTEM STORMWATER: REQUIREMENTS OF THE NATIONAL POLLUTANT DISCHARGE ELIMINATION SYSTEM (NPDES) GENERIC PERMIT FOR STORMWATER DISCHARGE FROM LARGE AND SMALL CONSTRUCTION ACTIVITIES (AKA. CONSTRUCTION GENERIC PERMIT, OR CGP).
- 2. A COPY OF THE CERTIFIED NPDES NOI, OR A COPY OF THE FDEP COVERAGE CONFIRMATION LETTER SHALL BE POSTED AT THE SITE IN ACCORDANCE WITH PART 2.6 OF THE GENERIC PERMIT, AND AS PER SEC 54-187(G)(1) OF THE SARASOTA COUNTY
- CONFIRMATION LETTER SHALL BE PROVIDED TO SARASOTA COUNTY WITHIN 7 CALENDAR DAYS IN ACCORDANCE WITH PART 2.6 OF THE GENERIC PERMIT, AND SEC.
- 4. THE SWPPP SHALL BE CERTIFIED IN ACCORDANCE WITH PART 4.6 OF THE GENERIC PERMIT, AND A COPY OF THE CERTIFIED DOCUMENT SHALL BE SUBMITTED TO SARASOTA COUNTY AT LEAST 48 HOURS PRIOR TO THE COMMENCEMENT OF CONSTRUCTION PER SEC 54-187(G)(1) OF THE SARASOTA COUNTY CODE.
- 5. A COPY OF THE SWPPP, AND COPIES OF THE INSPECTION AND MAINTENANCE RECORDS SHALL BE MAINTAINED AT THE PROJECT SITE, AND SHALL BE READILY AVAILABLE TO COUNTY OR STATE INSPECTORS PER SEC 54-187(G)(1) OF THE SARASOTA COUNTY CODE.
- COVERED AS OUTLINED UNDER PART 3.4 OF THE GENERIC PERMIT, THE DISCHARGE OF GROUNDWATER PRODUCED THROUGH DEWATERING, TO SURFACE WATERS, OR TO ANY PORTION OF THE MS4 WILL REQUIRE SEPARATE PERMITTING FROM THE FLORIDA DEPARTMENT OF ENVIRONMENTAL PROTECTION (DEP). PERMIT(S) SHALL BE OBTAINED PRIOR TO THE COMMENCEMENT OF DEWATERING. ANALYTICAL RESULTS FROM PRE-DISCHARGE TESTING SHALL BE PROVIDED TO SARASOTA COUNTY PURSUANT TO SECTION 54-185(B) OF THE SARASOTA COUNTY CODE.
- 1. THE STORM WATER POLLUTION PREVENTION PLAN ("SWPPP") IS COMPRISED OF THIS EROSION CONTROL PLAN. THE STANDARD DETAILS. THE PLAN NARRATIVE. ATTACHMENTS INCLUDED IN SPECIFICATIONS OF THE SWPPP, PLUS THE PERMIT AND ALL SUBSEQUENT REPORTS AND RELATED DOCUMENTS.
- 2. ALL CONTRACTORS AND SUBCONTRACTORS INVOLVED WITH STORM WATER POLLUTION PREVENTION SHALL OBTAIN A COPY OF THE STORM WATER POLLUTION PREVENTION PLAN AND THE STATE OF FLORIDA NATIONAL POLLUTANT DISCHARGE ELIMINATION SYSTEM GENERAL PERMIT (NPDES PERMIT) AND BECOME FAMILIAR WITH THEIR CONTENTS.
- THE CONTRACTOR SHALL IMPLEMENT BEST MANAGEMENT PRACTICES AS REQUIRED BY THE SWPPP. ADDITIONAL BEST MANAGEMENT PRACTICES SHALL BE IMPLEMENTED AS DICTATED BY CONDITIONS AT NO ADDITIONAL COST TO THE OWNER THROUGHOUT ALL PHASES OF CONSTRUCTION.
- BEST MANAGEMENT PRACTICES (BMP'S) AND CONTROLS SHALL CONFORM TO FEDERAL, STATE, OR LOCAL REQUIREMENTS OR MANUAL OF PRACTICE, AS APPLICABLE. THE CONTRACTOR SHALL IMPLEMENT ADDITIONAL CONTROLS AS DIRECTED BY THE PERMITTING AGENCY OR OWNER.
- 5. EROSION CONTROL PLAN MUST CLEARLY DELINEATE ALL STATE WATERS. PERMITS FOR ANY CONSTRUCTION ACTIVITY IMPACTING STATE WATERS OR REGULATED WETLANDS MUST BE MAINTAINED ON SITE AT ALL TIMES.
- 6. THE CONTRACTOR SHALL MINIMIZE CLEARING TO THE MAXIMUM EXTENT PRACTICAL OR AS REQUIRED BY THE GENERAL PERMIT.
- 7. CONTRACTOR SHALL DENOTE ON PLAN THE TEMPORARY PARKING AND STORAGE AREA WHICH SHALL ALSO BE USED AS THE EQUIPMENT MAINTENANCE AND CLEANING AREA, EMPLOYEE PARKING AREA, AND AREA FOR LOCATING PORTABLE FACILITIES, OFFICE TRAILERS, AND TOILET FACILITIES.
- 9. SUFFICIENT OIL AND GREASE ABSORBING MATERIALS AND FLOTATION BOOMS SHALL BE MAINTAINED ON SITE OR READILY AVAILABLE TO CONTAIN AND CLEAN-UP FUEL OR CHEMICAL SPILLS AND LEAKS.
- 11. RUBBISH, TRASH, GARBAGE, LITTER, OR OTHER SUCH MATERIALS SHALL BE DEPOSITED INTO SEALED CONTAINERS. MATERIALS SHALL BE PREVENTED FROM LEAVING THE PREMISES THROUGH THE ACTION OF WIND OR STORM WATER DISCHARGE INTO DRAINAGE DITCHES OR WATERS OF THE STATE.
- 12. ALL STORM WATER POLLUTION PREVENTION MEASURES PRESENTED ON THE PLAN, SHALL BE INITIATED AS SOON AS PRACTICABLE.

- IMMEDIATELY CORRECTED. SUCH INCIDENTS SHALL BE REPORTED TO SARASOTA COUNTY
- RULE 62-296.320(4)(C)1, F.A.C., BY TAKING APPROPRIATE MEASURES TO STABILIZE AFFECTED AREAS.
- WATERBODIES, OR FUEL AND OTHER PETROLEUM PRODUCT SPILLS THAT ARE IN EXCESS OF
- g. FERTILIZER APPLICATION SHALL BE CONSISTENT WITH CHAPTER 54, ARTICLE XXXII
- NPDES CONSTRUCTION GENERIC PERMIT COVERAGE SHALL BE OBTAINED AT LEAST 48 HOURS IN ADVANCE OF CONSTRUCTION COMMENCEMENT IN ACCORDANCE WITH THE
- 3. A COPY OF THE CERTIFIED NPDES NOI, OR A COPY OF THE FDEP COVERAGE 54-187(G)(1) OF THE SARASOTA COUNTY CODE.
- NATIONAL POLLUTANT DISCHARGE ELIMINATION SYSTEM DEWATERING: IF NOT OTHERWISE

EROSION CONTROL NOTES

- 8. ALL WASH WATER (CONCRETE TRUCKS, VEHICLE CLEANING, EQUIPMENT CLEANING, ETC.) SHALL BE DETAINED AND PROPERLY TREATED OR DISPOSED.
- 10. THE CONTRACTOR SHALL BE RESPONSIBLE FOR DUST CONTROL ON SITE. THE USE OF MOTOR OILS AND OTHER PETROLEUM BASED OR TOXIC LIQUIDS FOR DUST SUPPRESSION OPERATIONS IS PROHIBITED.

13. STABILIZATION PRACTICES SHOULD BE INITIATED AS SOON AS PRACTICAL, BUT IN NO CASE MORE THAN 7 DAYS WHERE CONSTRUCTION HAS TEMPORARILY CEASED. 14. DISTURBED PORTIONS OF THE SITE WHERE CONSTRUCTION ACTIVITY HAS

EROSION CONTROL NOTES (CONT.)

- PERMANENTLY STOPPED SHALL BE PERMANENTLY SEEDED. THESE AREAS SHALL BE SEEDED NO LATER THAN 7 DAYS AFTER THE LAST CONSTRUCTION ACTIVITY OCCURRED IN THESE AREAS. REFER TO SECTION 981 OF THE STANDARD SPECIFICATIONS FOR SEEDING AND MAINTENANCE REQUIREMENTS.
- 15. IF THE ACTION OF VEHICLES TRAVELING OVER THE GRAVEL CONSTRUCTION ENTRANCES IS NOT SUFFICIENT TO REMOVE THE MAJORITY OF DIRT OR MUD. THEN THE TIRES MUST BE WASHED BEFORE THE VEHICLES ENTER A PUBLIC ROAD. IF WASHING IS USED, PROVISIONS MUST BE MADE TO INTERCEPT THE WASH WATER AND TRAP THE SEDIMENT BEFORE IT IS CARRIED OFF THE SITE.
- 16. ALL MATERIALS SPILLED, DROPPED, WASHED, OR TRACKED FROM VEHICLES ONTO ROADWAYS OR INTO STORM DRAINS MUST BE REMOVED AS SOON AS POSSIBLE.
- 17. THE CONTRACTOR SHALL BE RESPONSIBLE FOR REMOVING SEDIMENT IN THE DETENTION POND AND ANY SEDIMENT THAT MAY HAVE COLLECTED IN THE STORM SEWER DRAINAGE SYSTEMS IN CONJUNCTION WITH THE STABILIZATION OF THE SITE.
- 18. ON-SITE & OFF SITE SOIL STOCKPILE AND BORROW AREAS SHALL BE PROTECTED FROM EROSION AND SEDIMENTATION THROUGH IMPLEMENTATION OF BEST MANAGEMENT PRACTICES. STOCKPILE AND BORROW AREA LOCATIONS SHALL BE NOTED ON THE EROSION CONTROL PLAN AND PERMITTED IN ACCORDANCE WITH GENERAL PERMIT REQUIREMENTS.
- 19. SLOPES SHALL BE LEFT IN A ROUGHENED CONDITION DURING THE GRADING PHASE TO REDUCE RUNOFF VELOCITIES AND EROSION.
- 20. DUE TO GRADE CHANGES DURING THE DEVELOPMENT OF THE PROJECT. THE CONTRACTOR SHALL BE RESPONSIBLE FOR ADJUSTING THE EROSION CONTROL MEASURES (SILT FENCES, ETC.) TO PREVENT EROSION.
- 21. ALL CONSTRUCTION SHALL BE STABILIZED AT THE END OF EACH WORKING DAY, THIS INCLUDES BACK FILLING OF TRENCHES FOR UTILITY CONSTRUCTION AND PLACEMENT OF GRAVEL OR BITUMINOUS PAVING FOR ROAD CONSTRUCTION.

0

RANCH


THE PRESENCE OF GROUNDWATER SHOULD BE ANTICIPATED ON THIS PROJECT, CONTRACTOR'S BID SHALL INCLUDE CONSIDERATION FOR ADDRESSING THIS ISSUE.


CALL 2 WORKING DAYS BEFORE YOU DIG IT'S THE LAW!


DIAL 811


Call before you dig SUNSHINE STATE ONE CALL OF FLORIDA, IN


SHEET NUMBER A-2

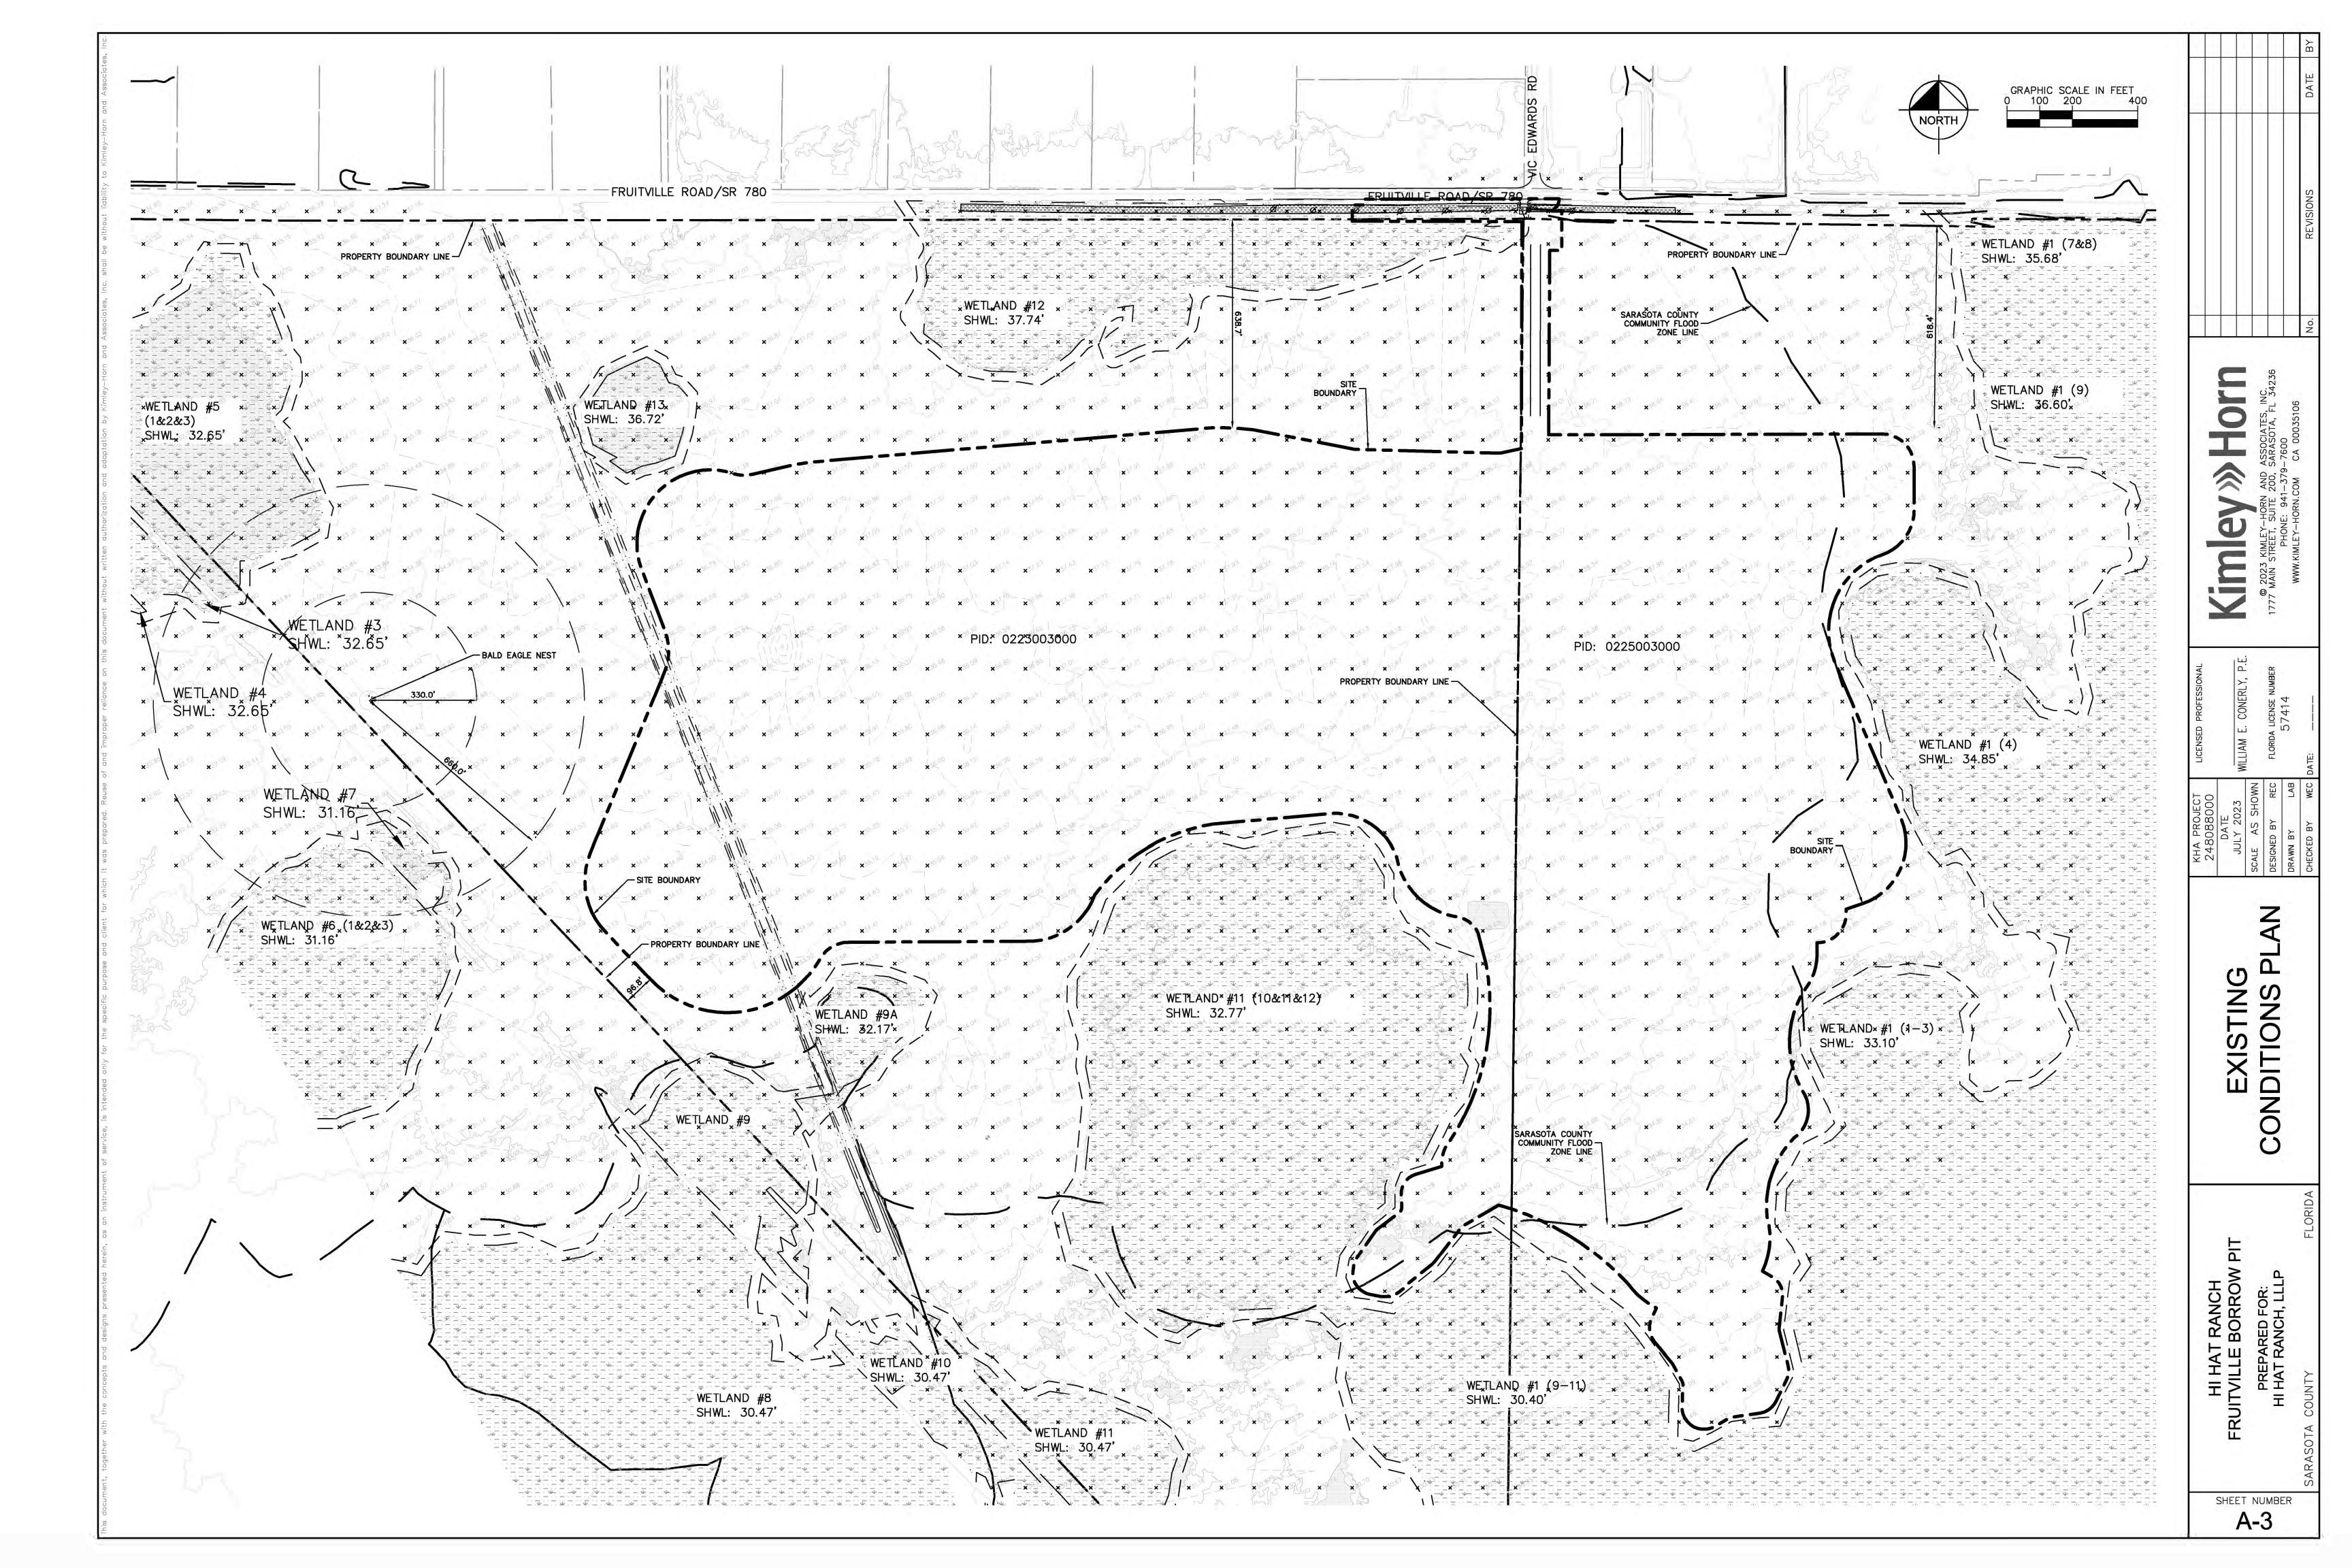

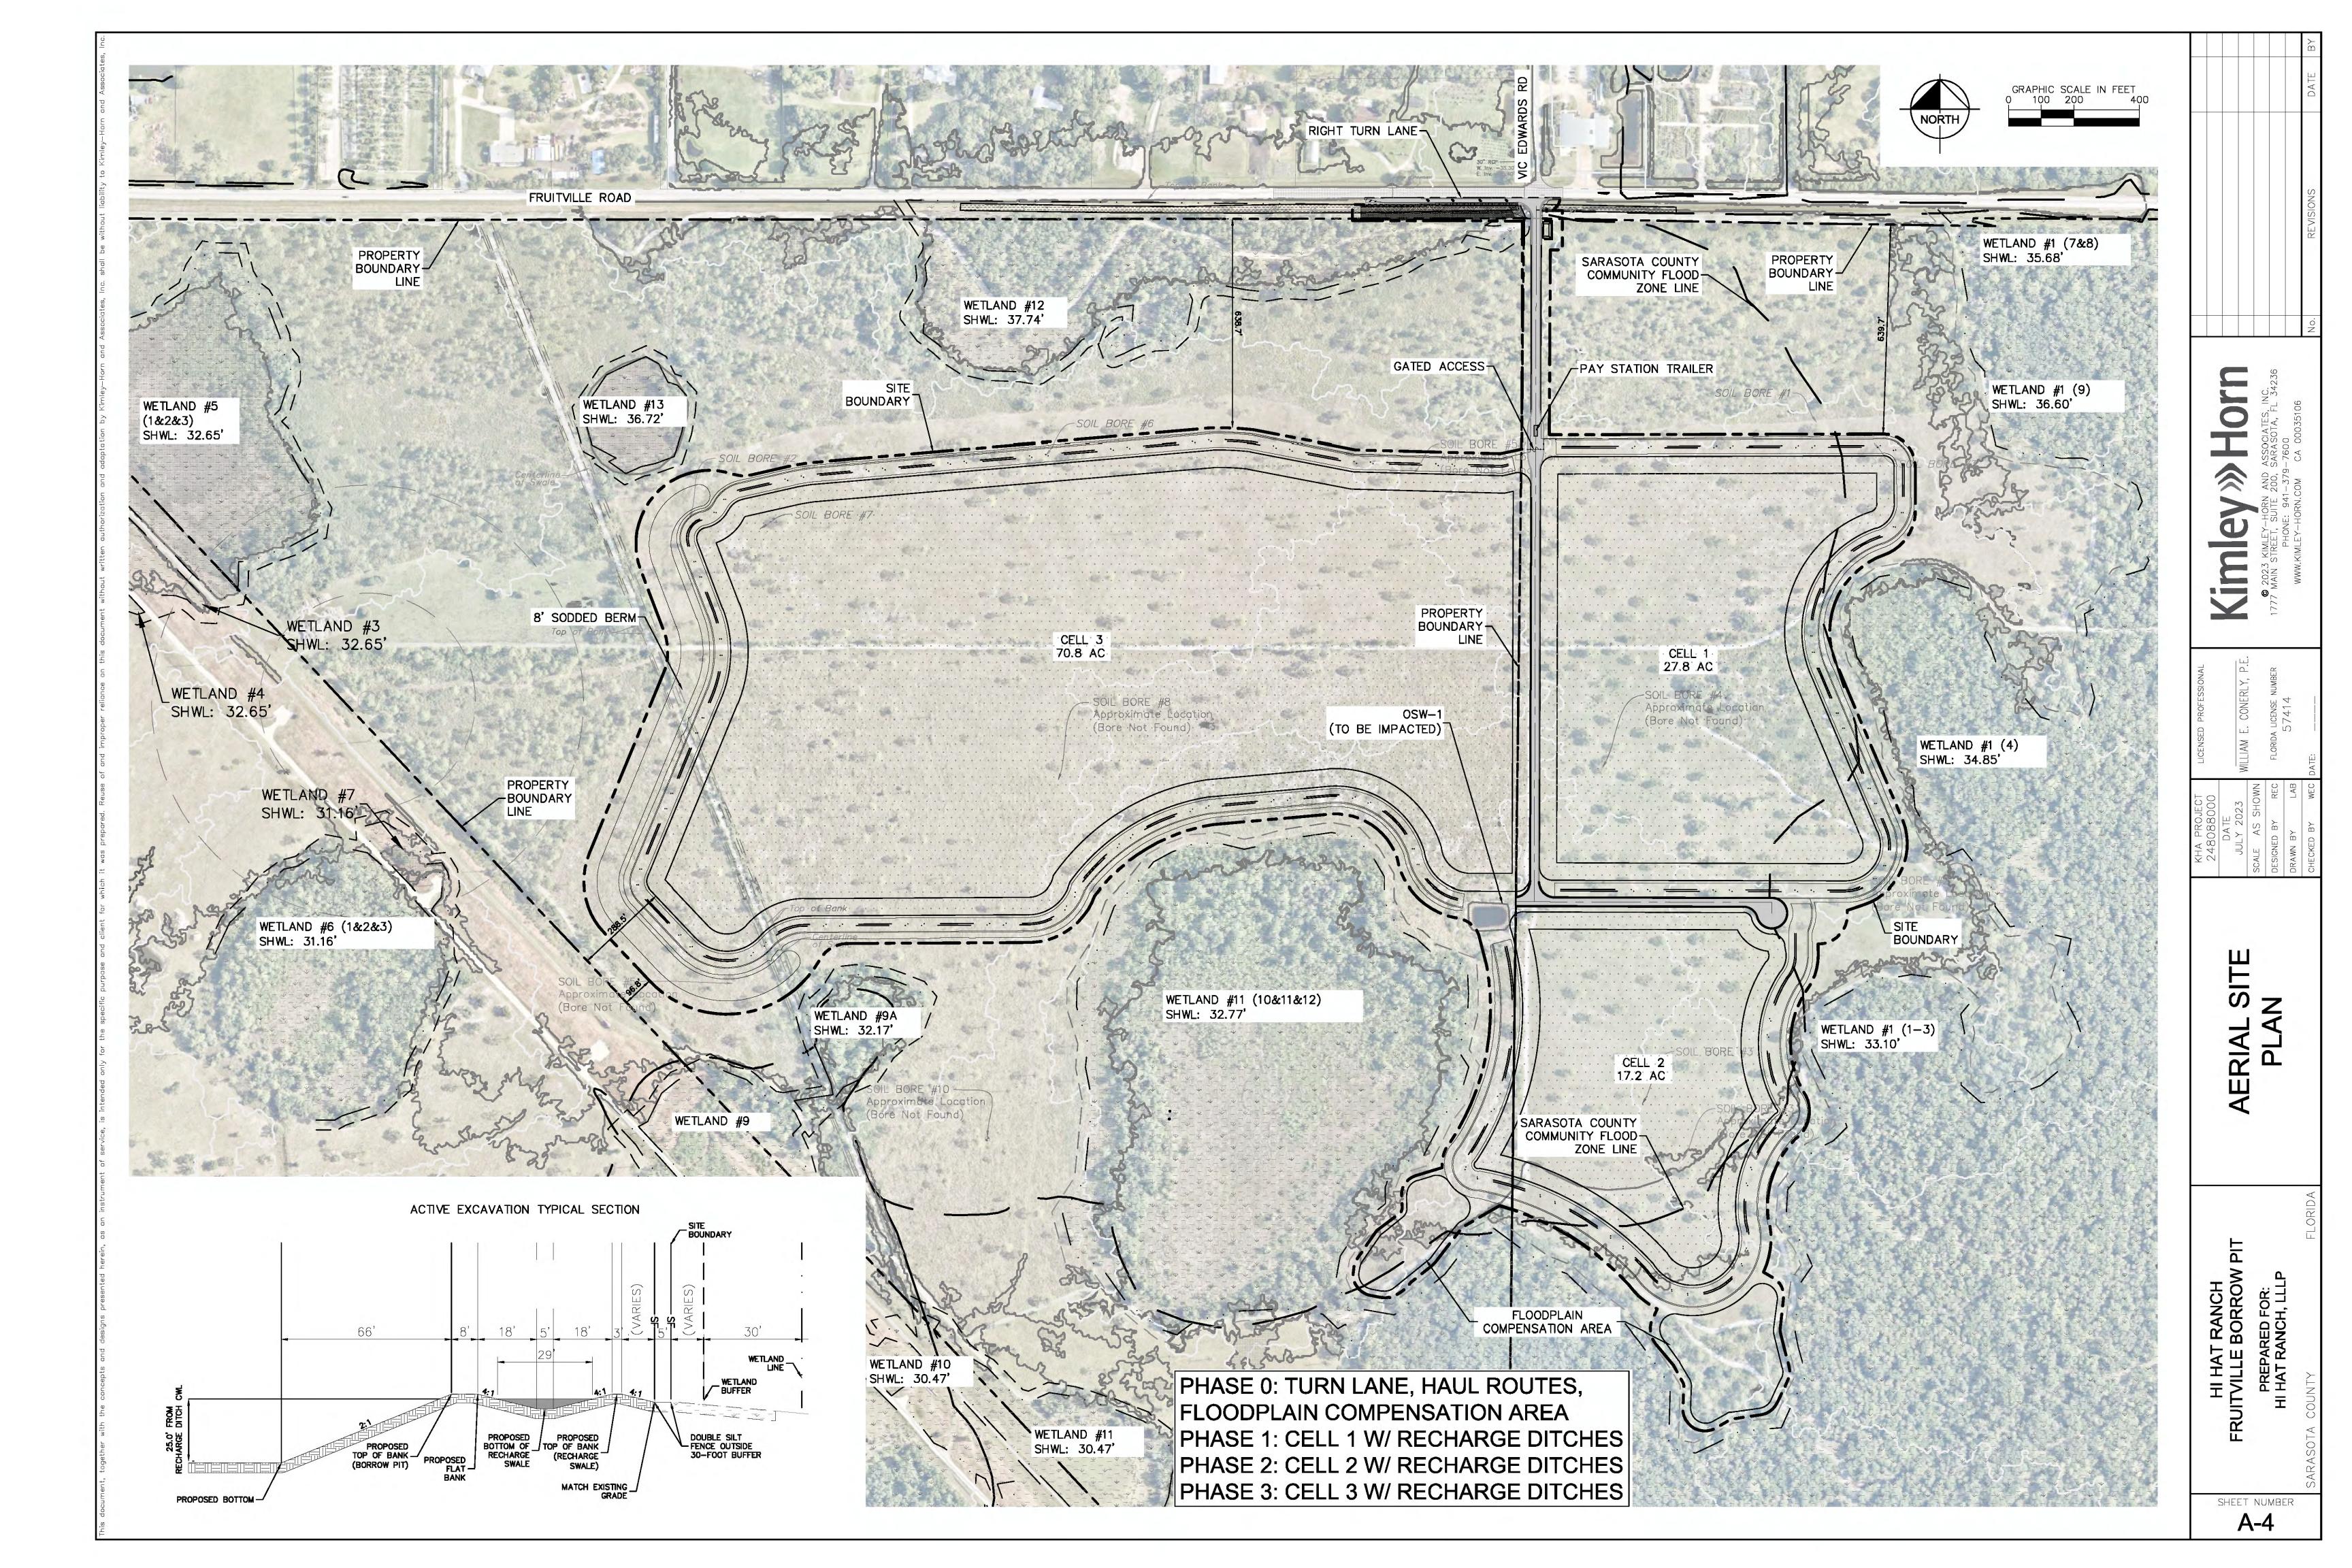

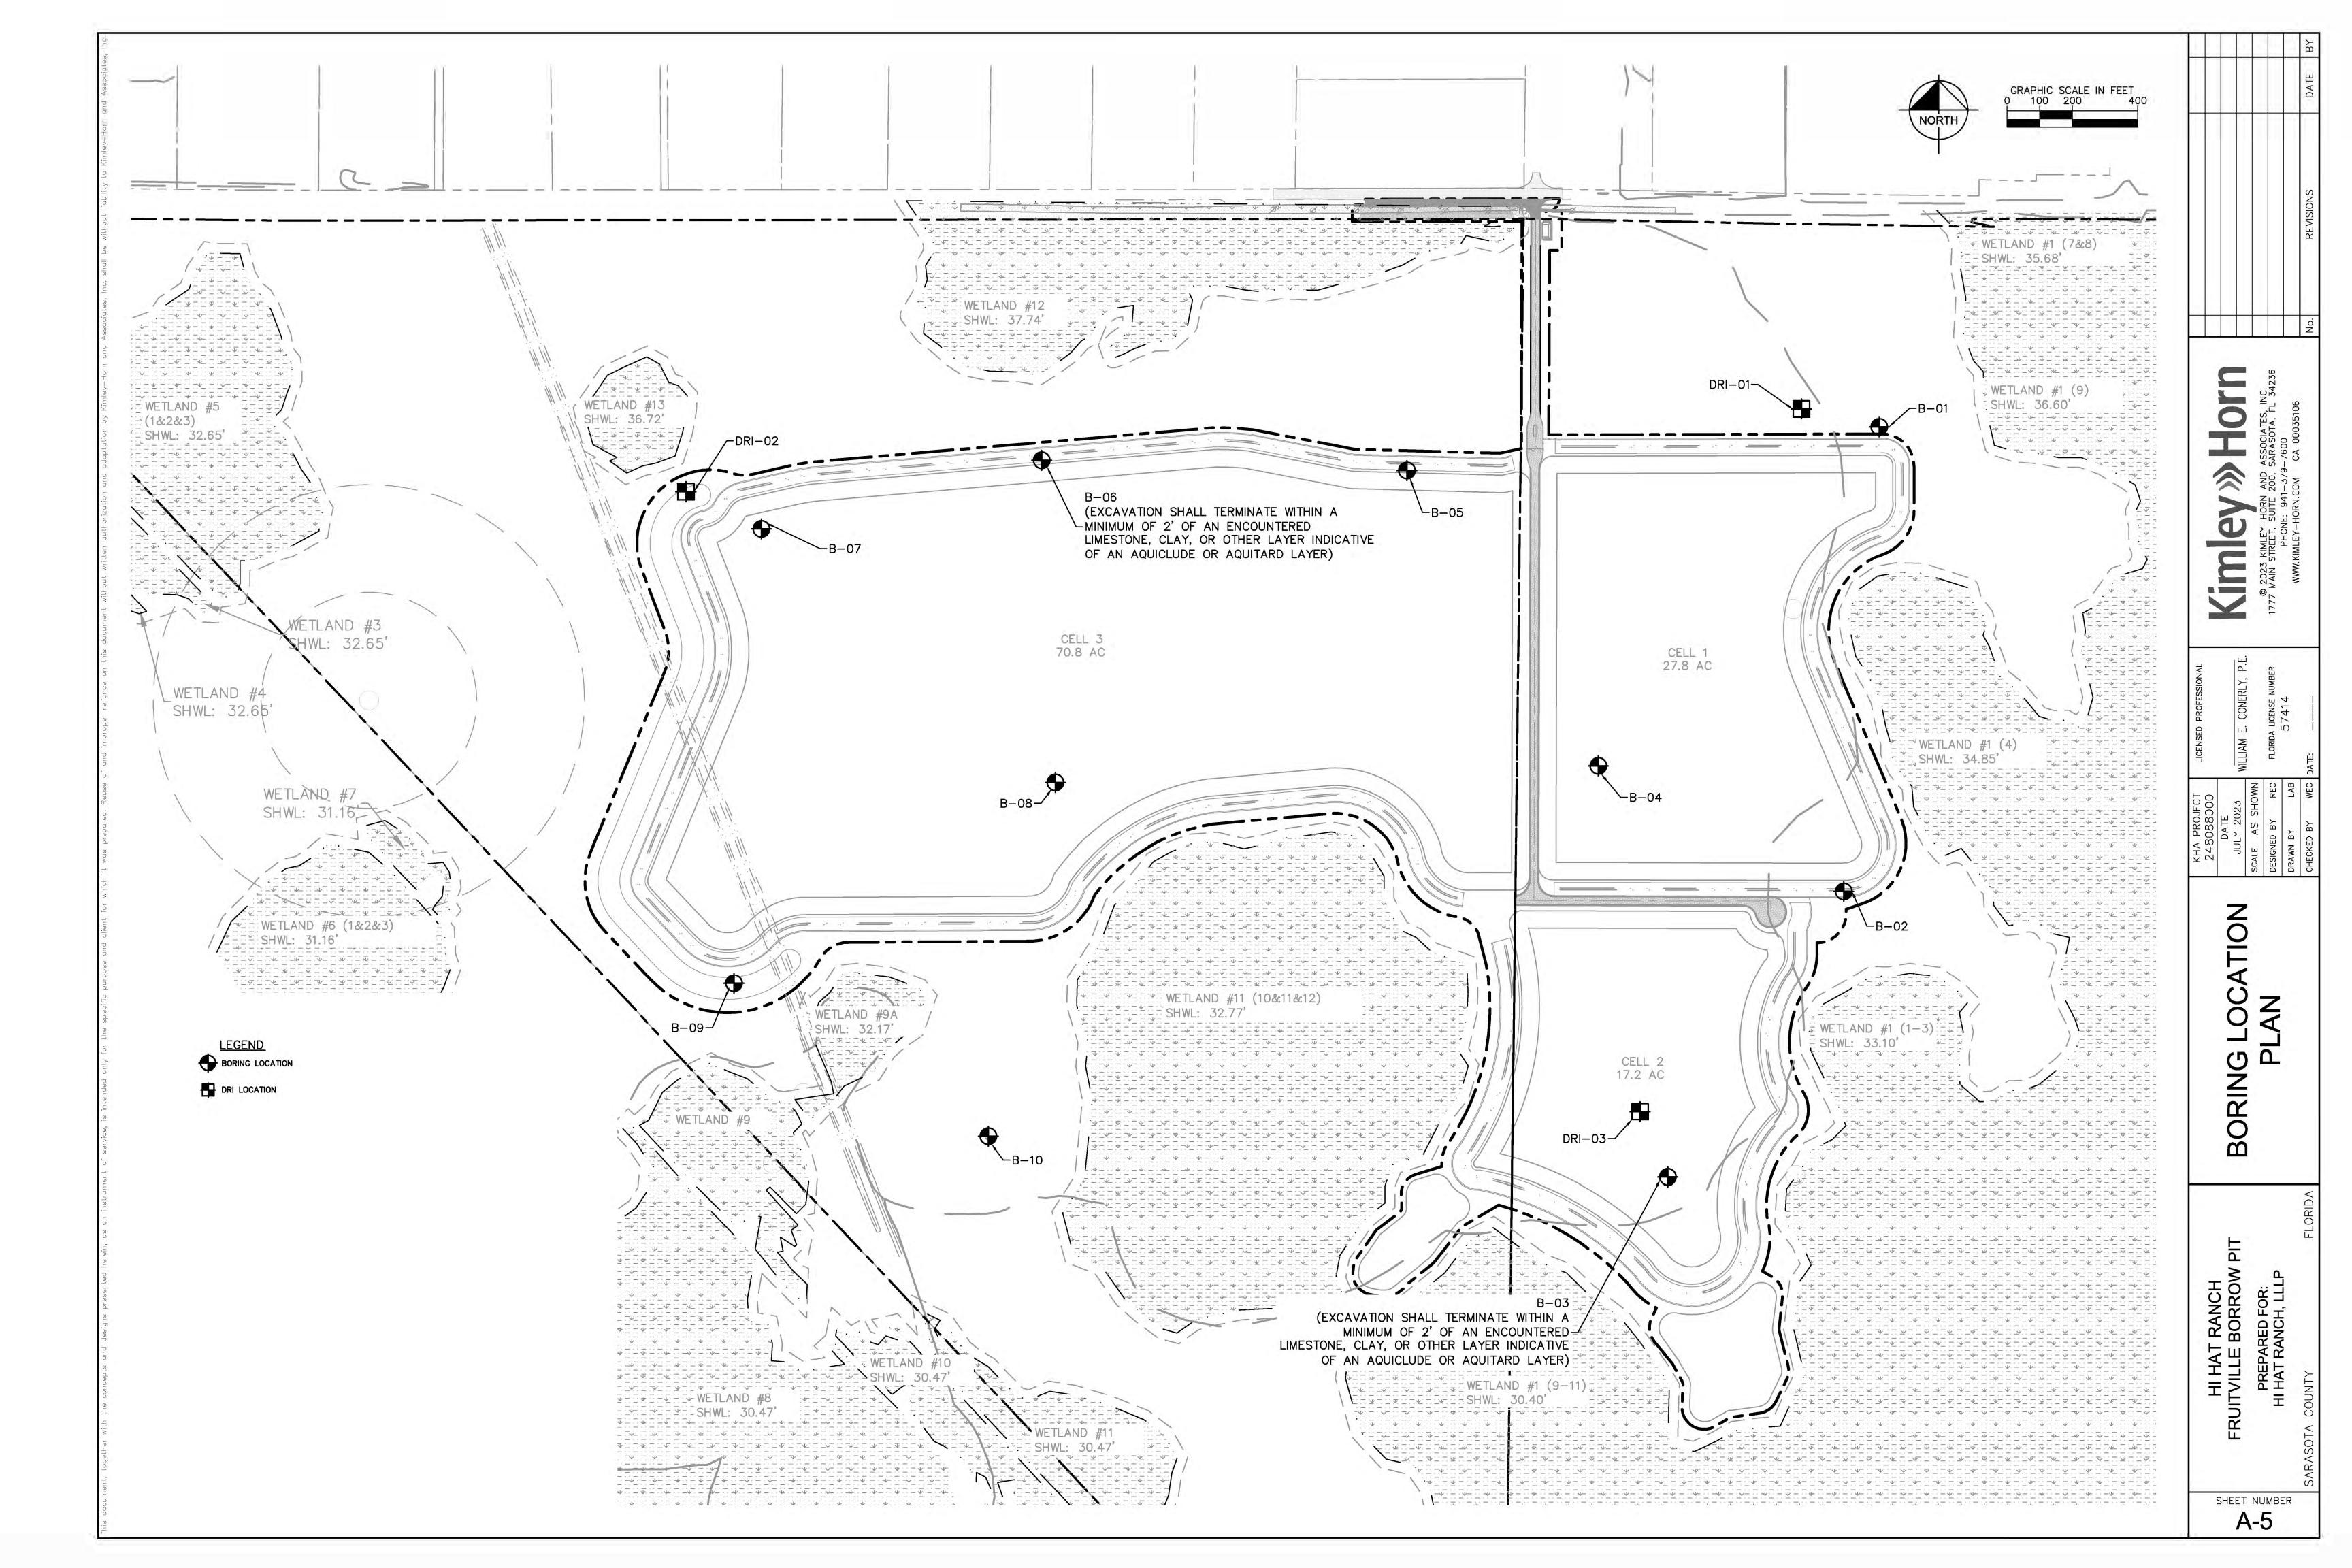

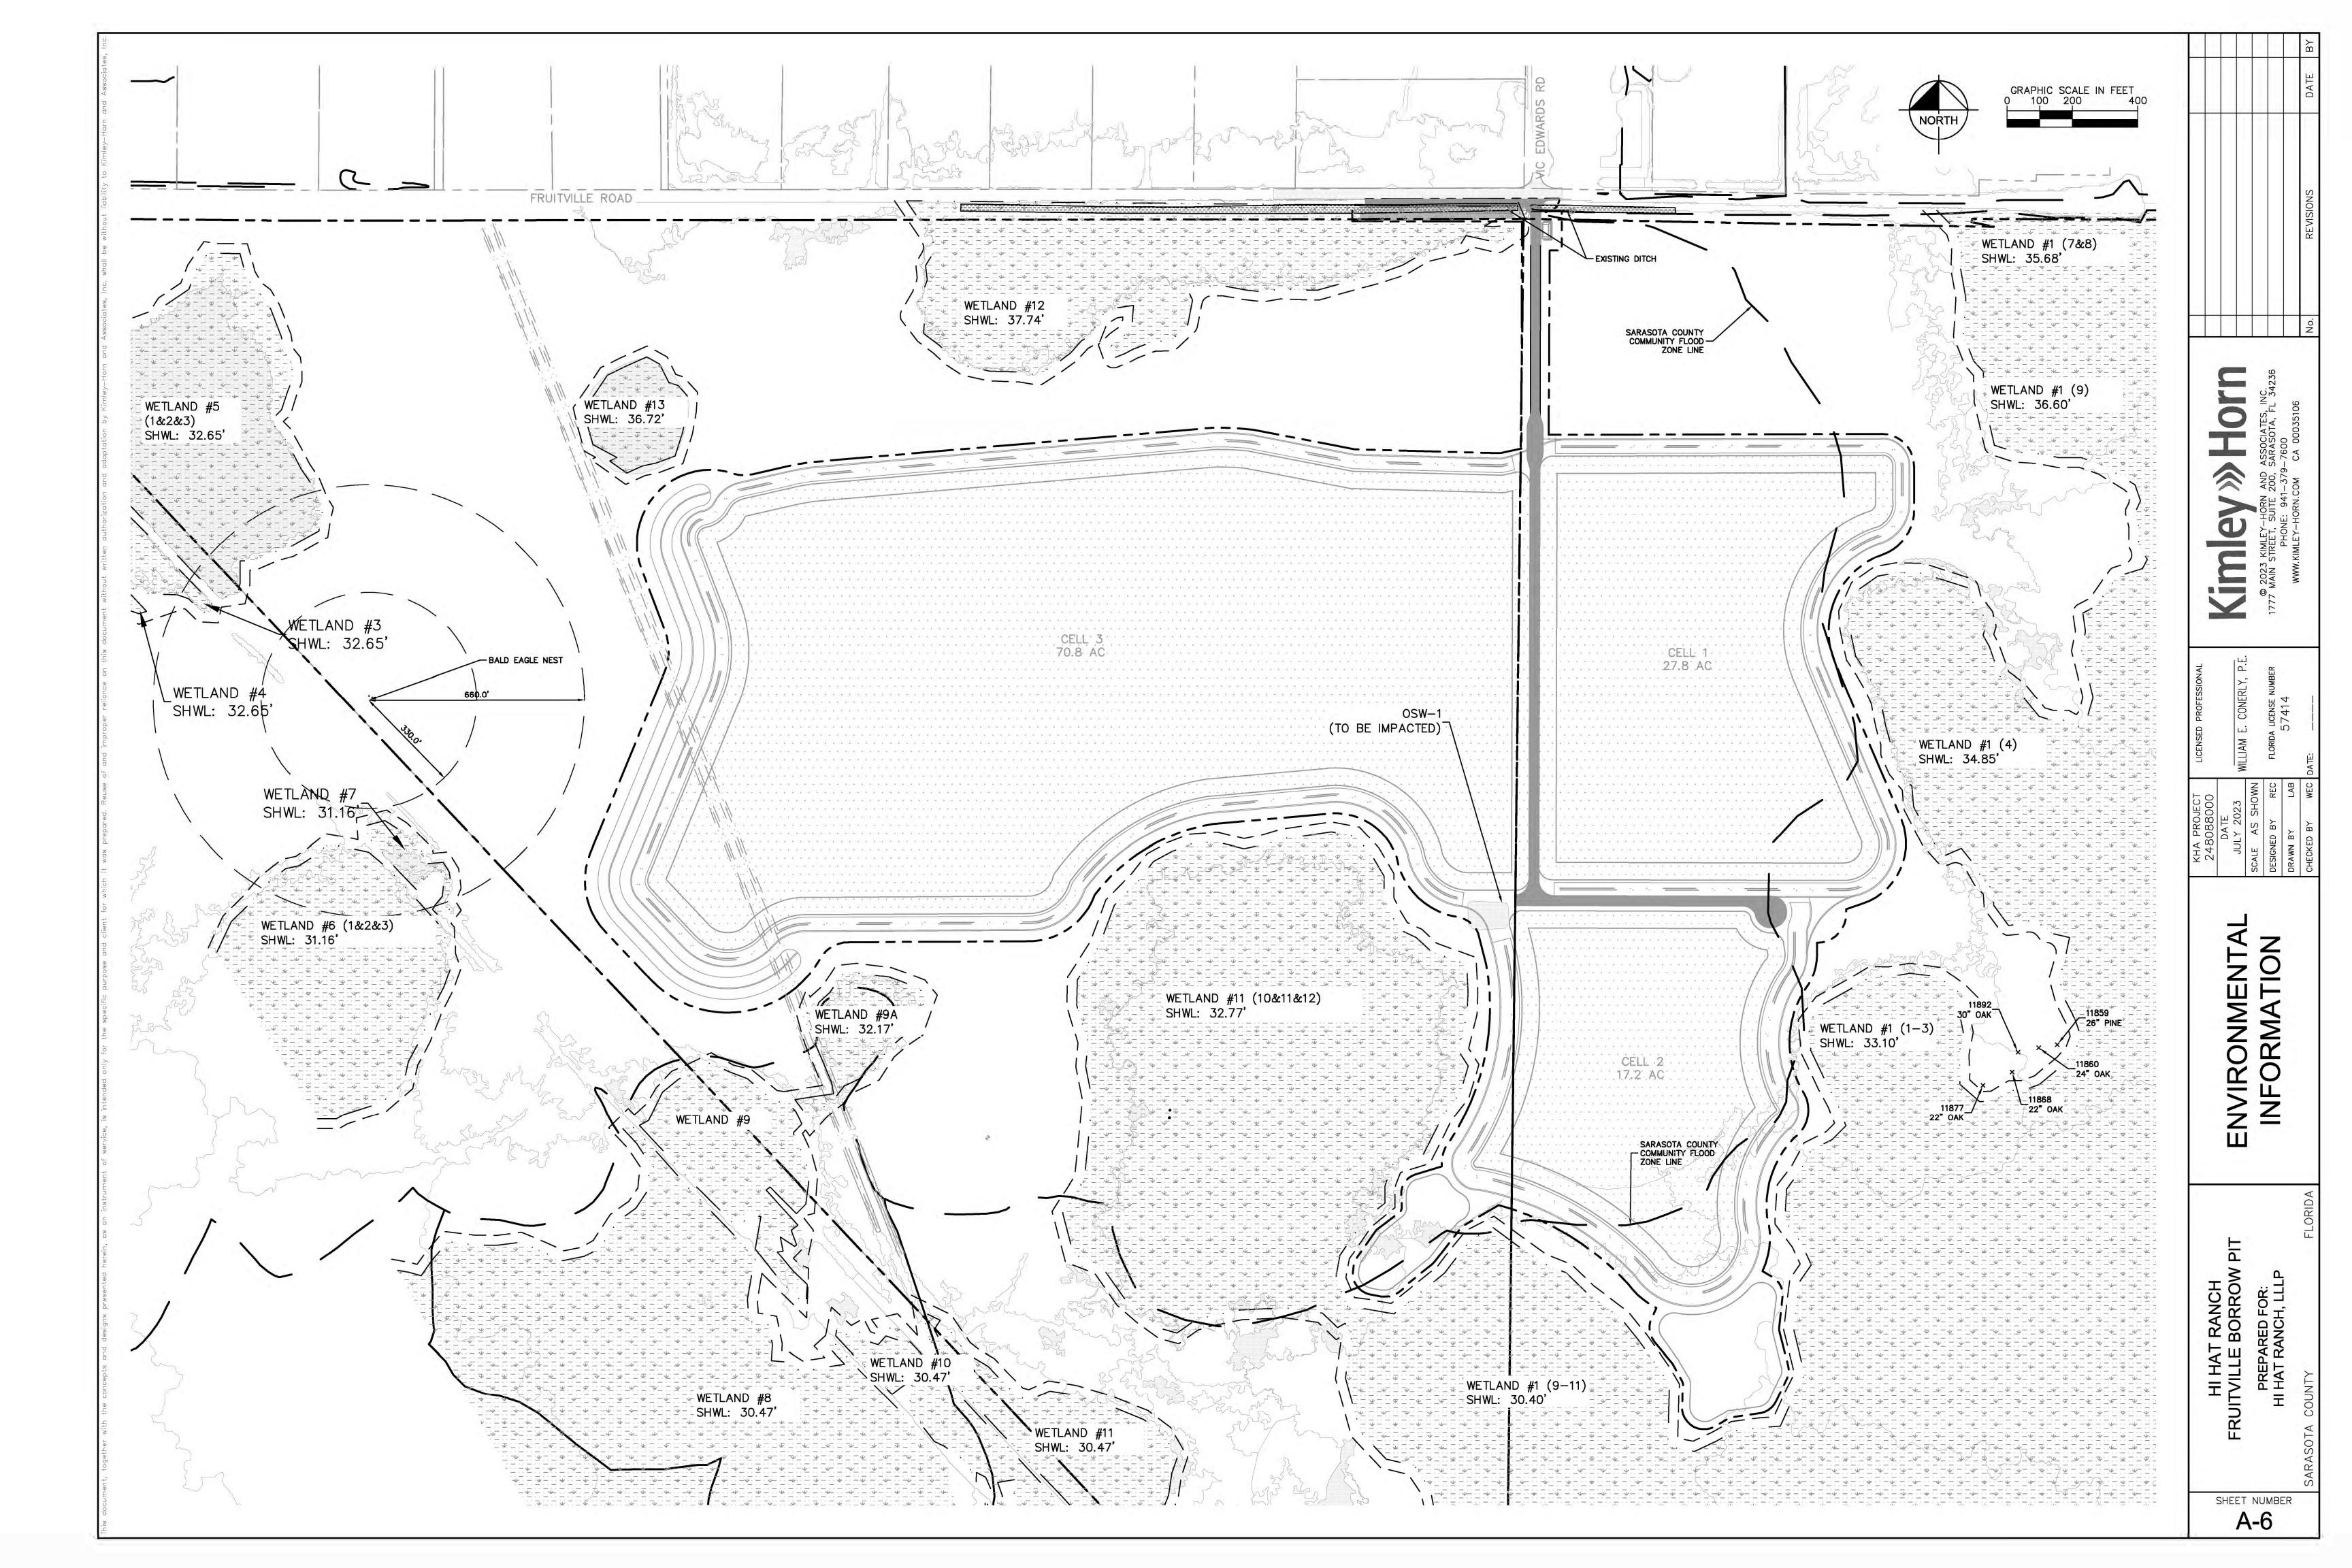

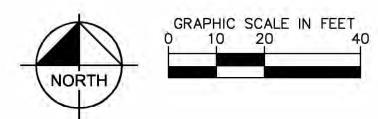

Planting Plan Common Name Slash pine Wax myrtle Sand cordgrass Fakahatchee Species Name Pinus elliottii Myrica cerifera Spartina bakeri Tripsacum dactyoides 3' O.C. 3' O.C. 10' O.C. 5' O.C. 3 gal qt. eq. qt. eq. Acreage Percentage 50% 30% 35% 35% TOTAL 748 SF

| | | | | | Planting Plan | | |
|--------------------------------------|---------|--------------|-----------------|--------------------|-------------------|-----------------|-------|
| | | Common Name | Wax myrtle | Sawgrass | Maidencane | Sand cordgrass | |
| | | Species Name | Myrica cerifera | Cladium jamaicense | Panicum hemitomon | Spartina bakeri | |
| | | Spacing | 5' O.C. | 3' O.C. | 3' O.C. | 3' O.C. | |
| | | Size | 3 gal | qt. eq. | qt. eq. | qt. eq. | |
| Wetland ID | Acreage | Percentage | 50% | 20% | 20% | 10% | TOTAL |
| Temporary Wetland Impacts (WL-12) | 0.06 | 2.716 SF | 52 | 58 | 58 | 29 | 19 |

Table 1. Supplemental Planting Table for Hi Hat Ranch Fruitville Borrow Pit, Temporary Buffer and Temporary Wetland Impacts

Wetland ID

Temporary Upland Buffer (WL-12)

| <u>LEGEN</u> | I <u>D</u> |
|--------------|--|
| PROPOSED | DIRECT OSW IMPACT (4,021 SF) |
| PROPOSED | TEMPORARY WETLAND BUFFER IMPACT (748 SF) |
| PROPOSED | SECONDARY WETLAND IMPACT (11,810 SF) |
| PROPOSED | DIRECT WETLAND IMPACT (7,079 SF) |
| PROPOSED | TEMPORARY WETLAND IMPACT WITH SILT FENCE INSTALLATION (2,716 |

NOTE: IMPROVEMENTS WITHIN SARASOTA COUNTY RIGHT-OF-WAY ARE SHOWN ONLY FOR INFORMATIONAL PURPOSES. RIGHT-OF-WAY IMPROVEMENTS SHALL NOT BE CONSTRUCTED UNTIL SITE AND DEVELOPMENT PLAN APPROVAL.


Kim


AND IMPACT AN ENSATION

HABITAT IMPA COMPENSA

HI HAT RANCH FRUITVILLE BORROW

SHEET NUMBER **A-7**

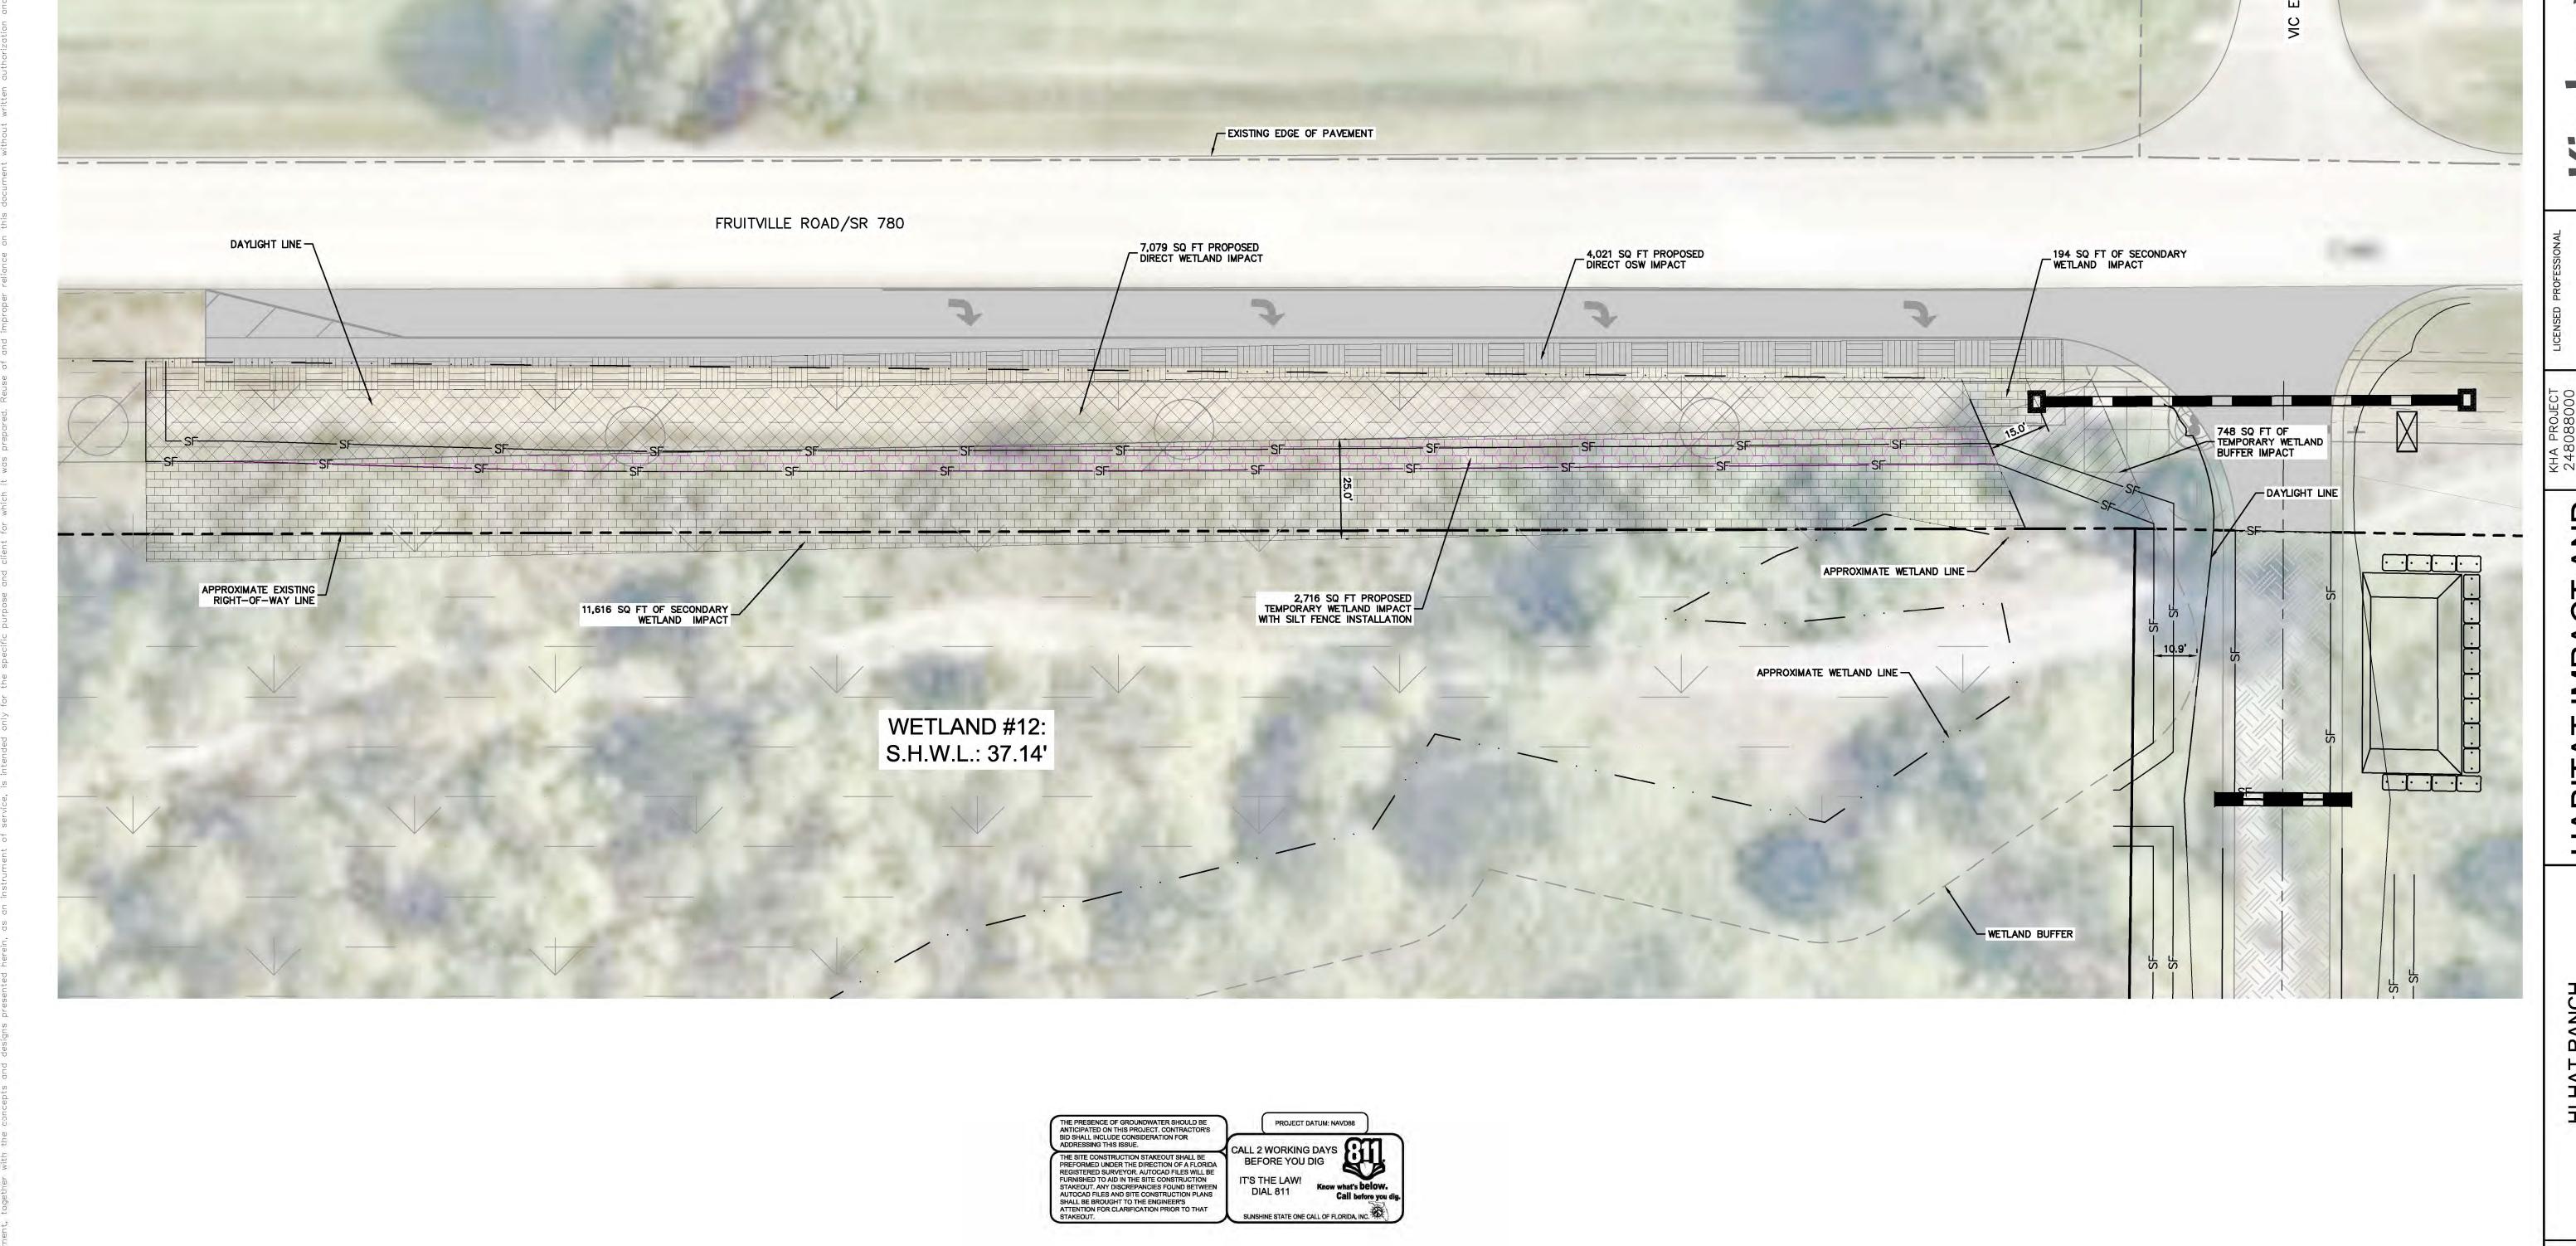

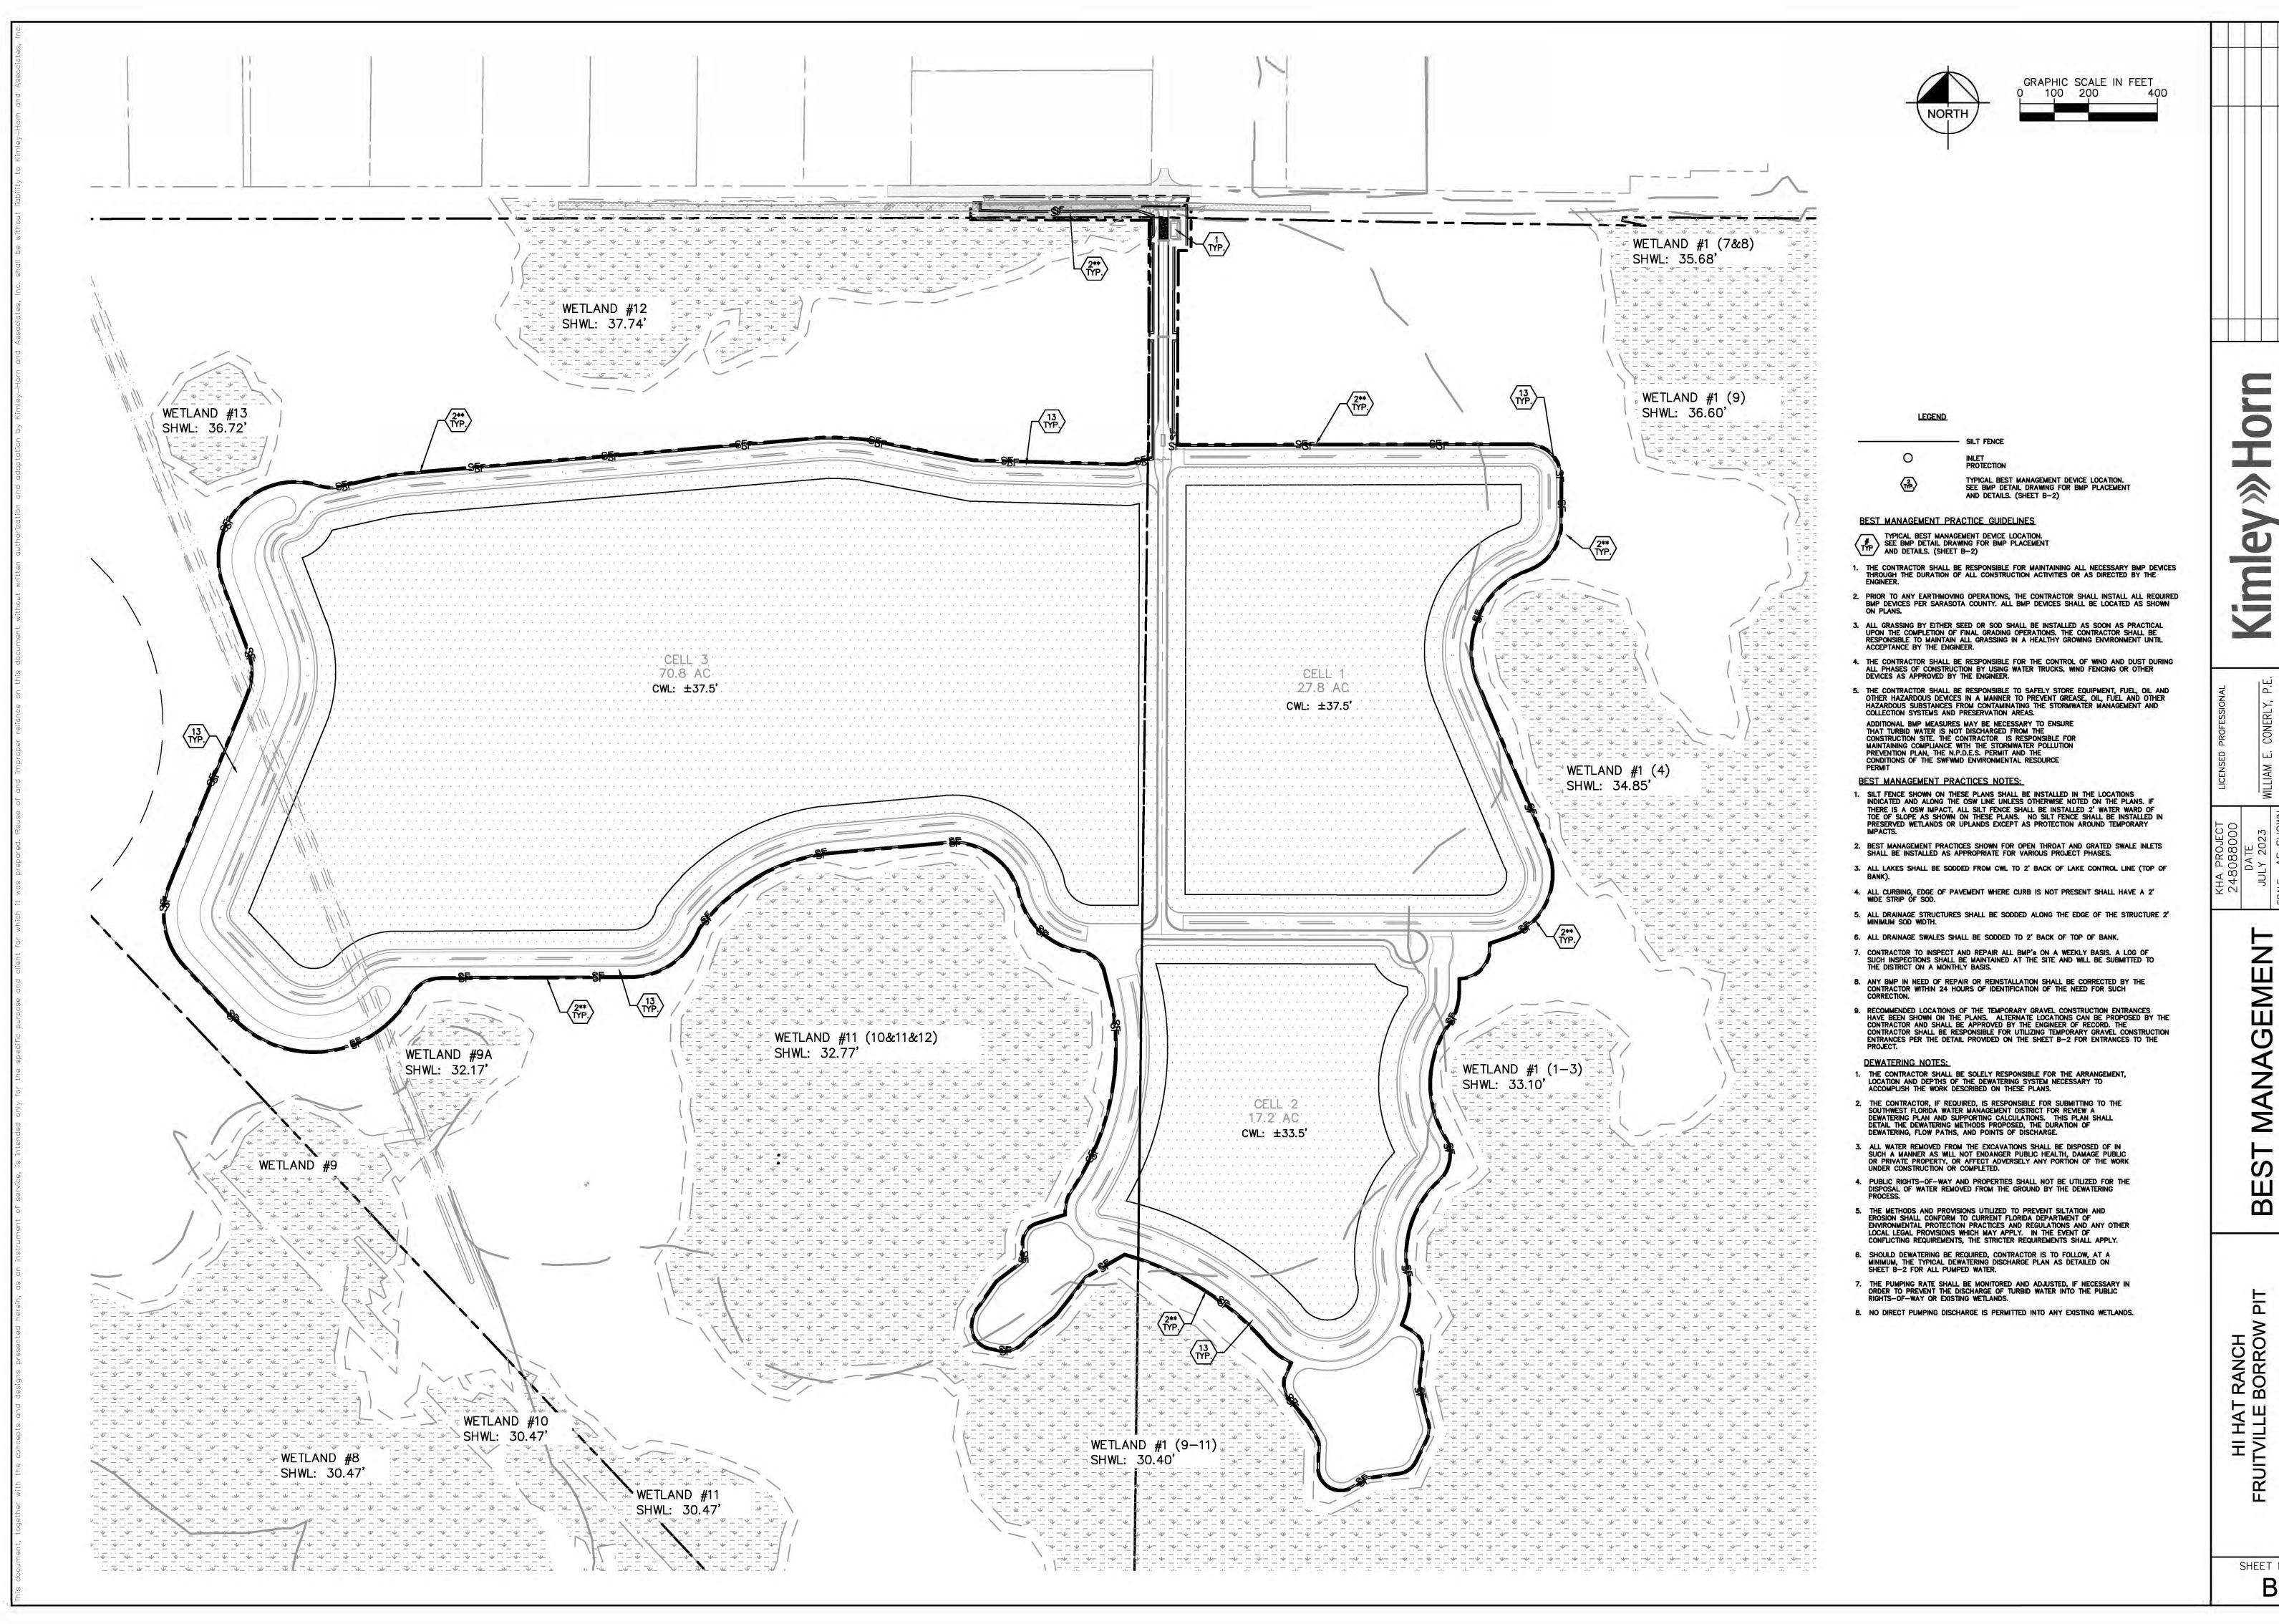

5


P.F.


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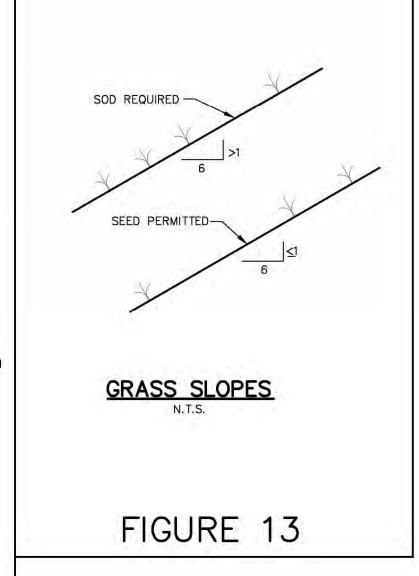
BEST PRA

FIT - RANCH BORROW PREPARED FOR: I HAT RANCH, LLL Ξ

> SHEET NUMBER **B-1**



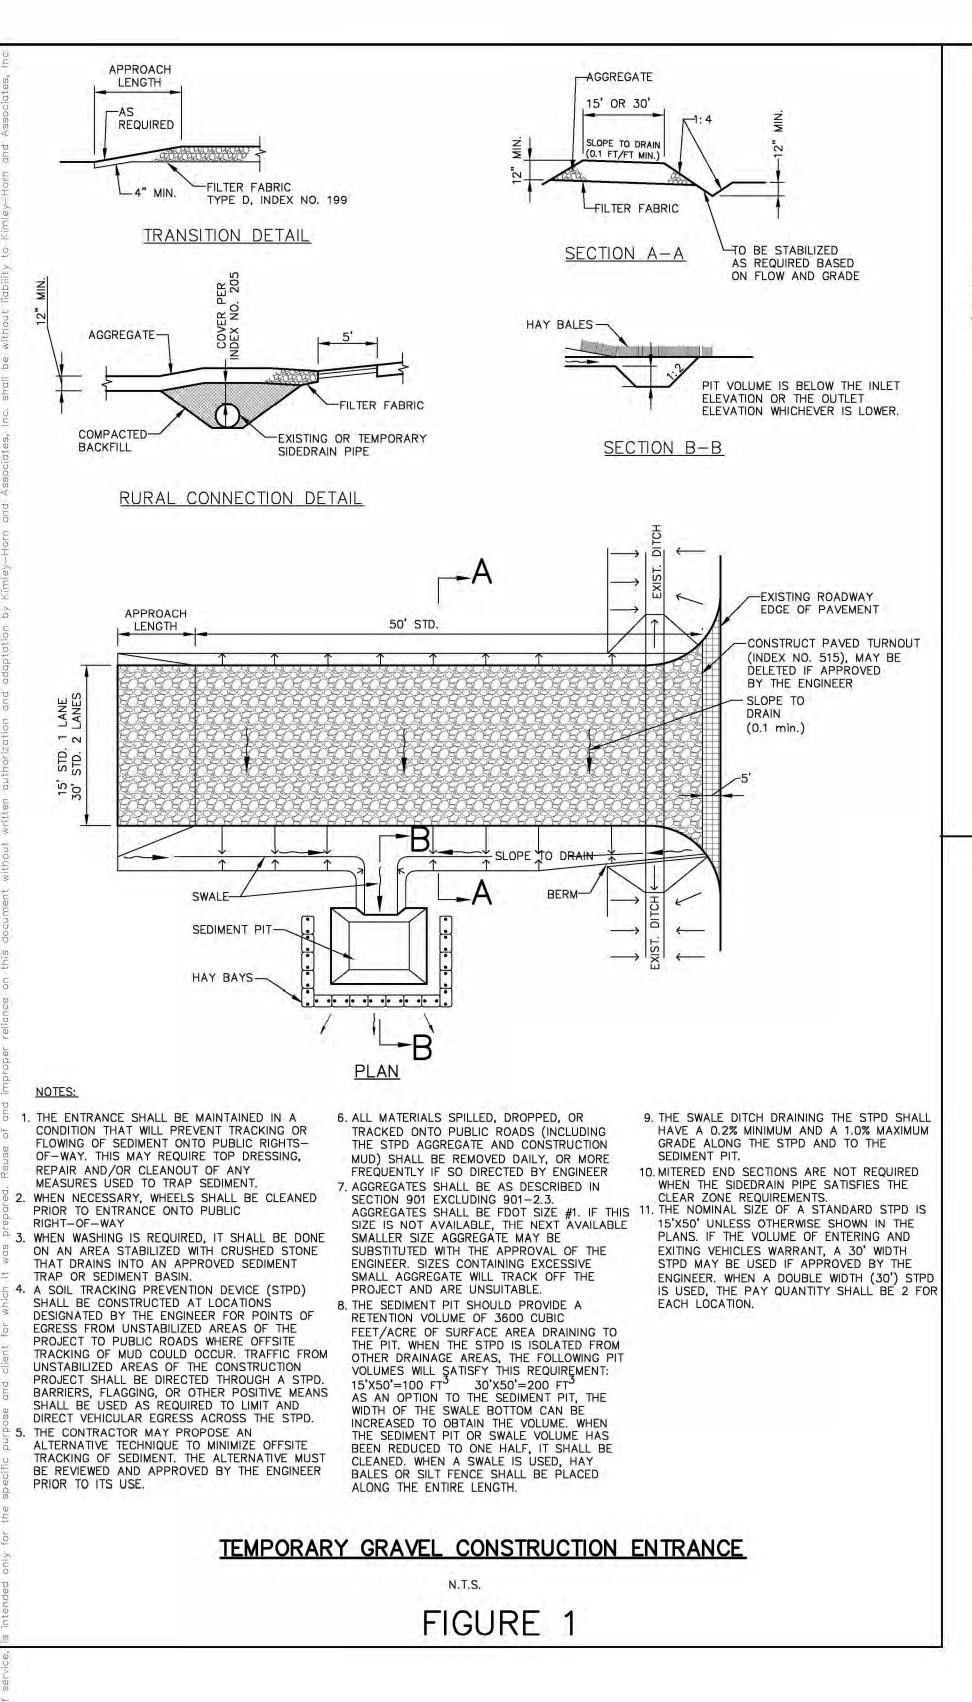

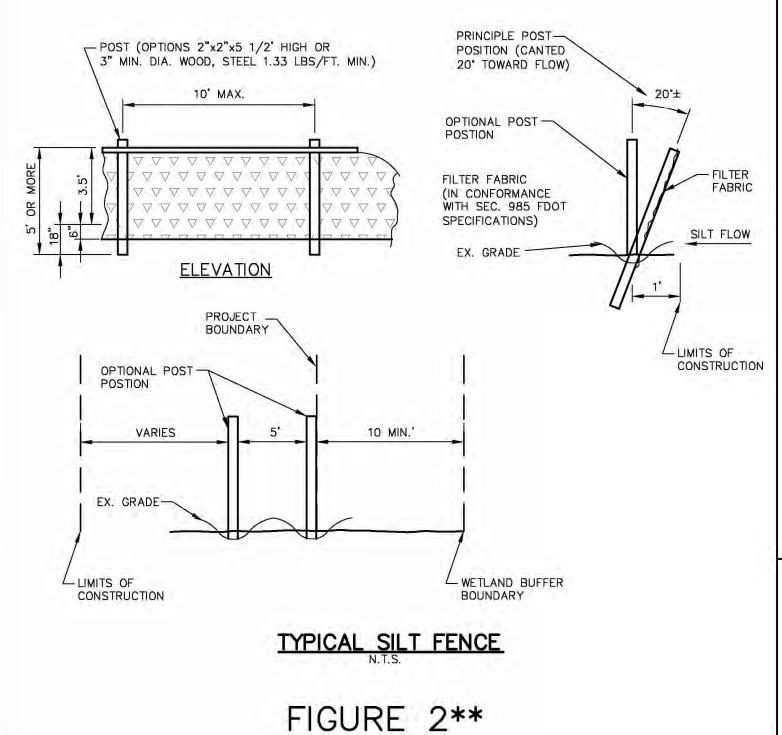

GEMEN DETAIL BEST PRAC - RANCH BORROW


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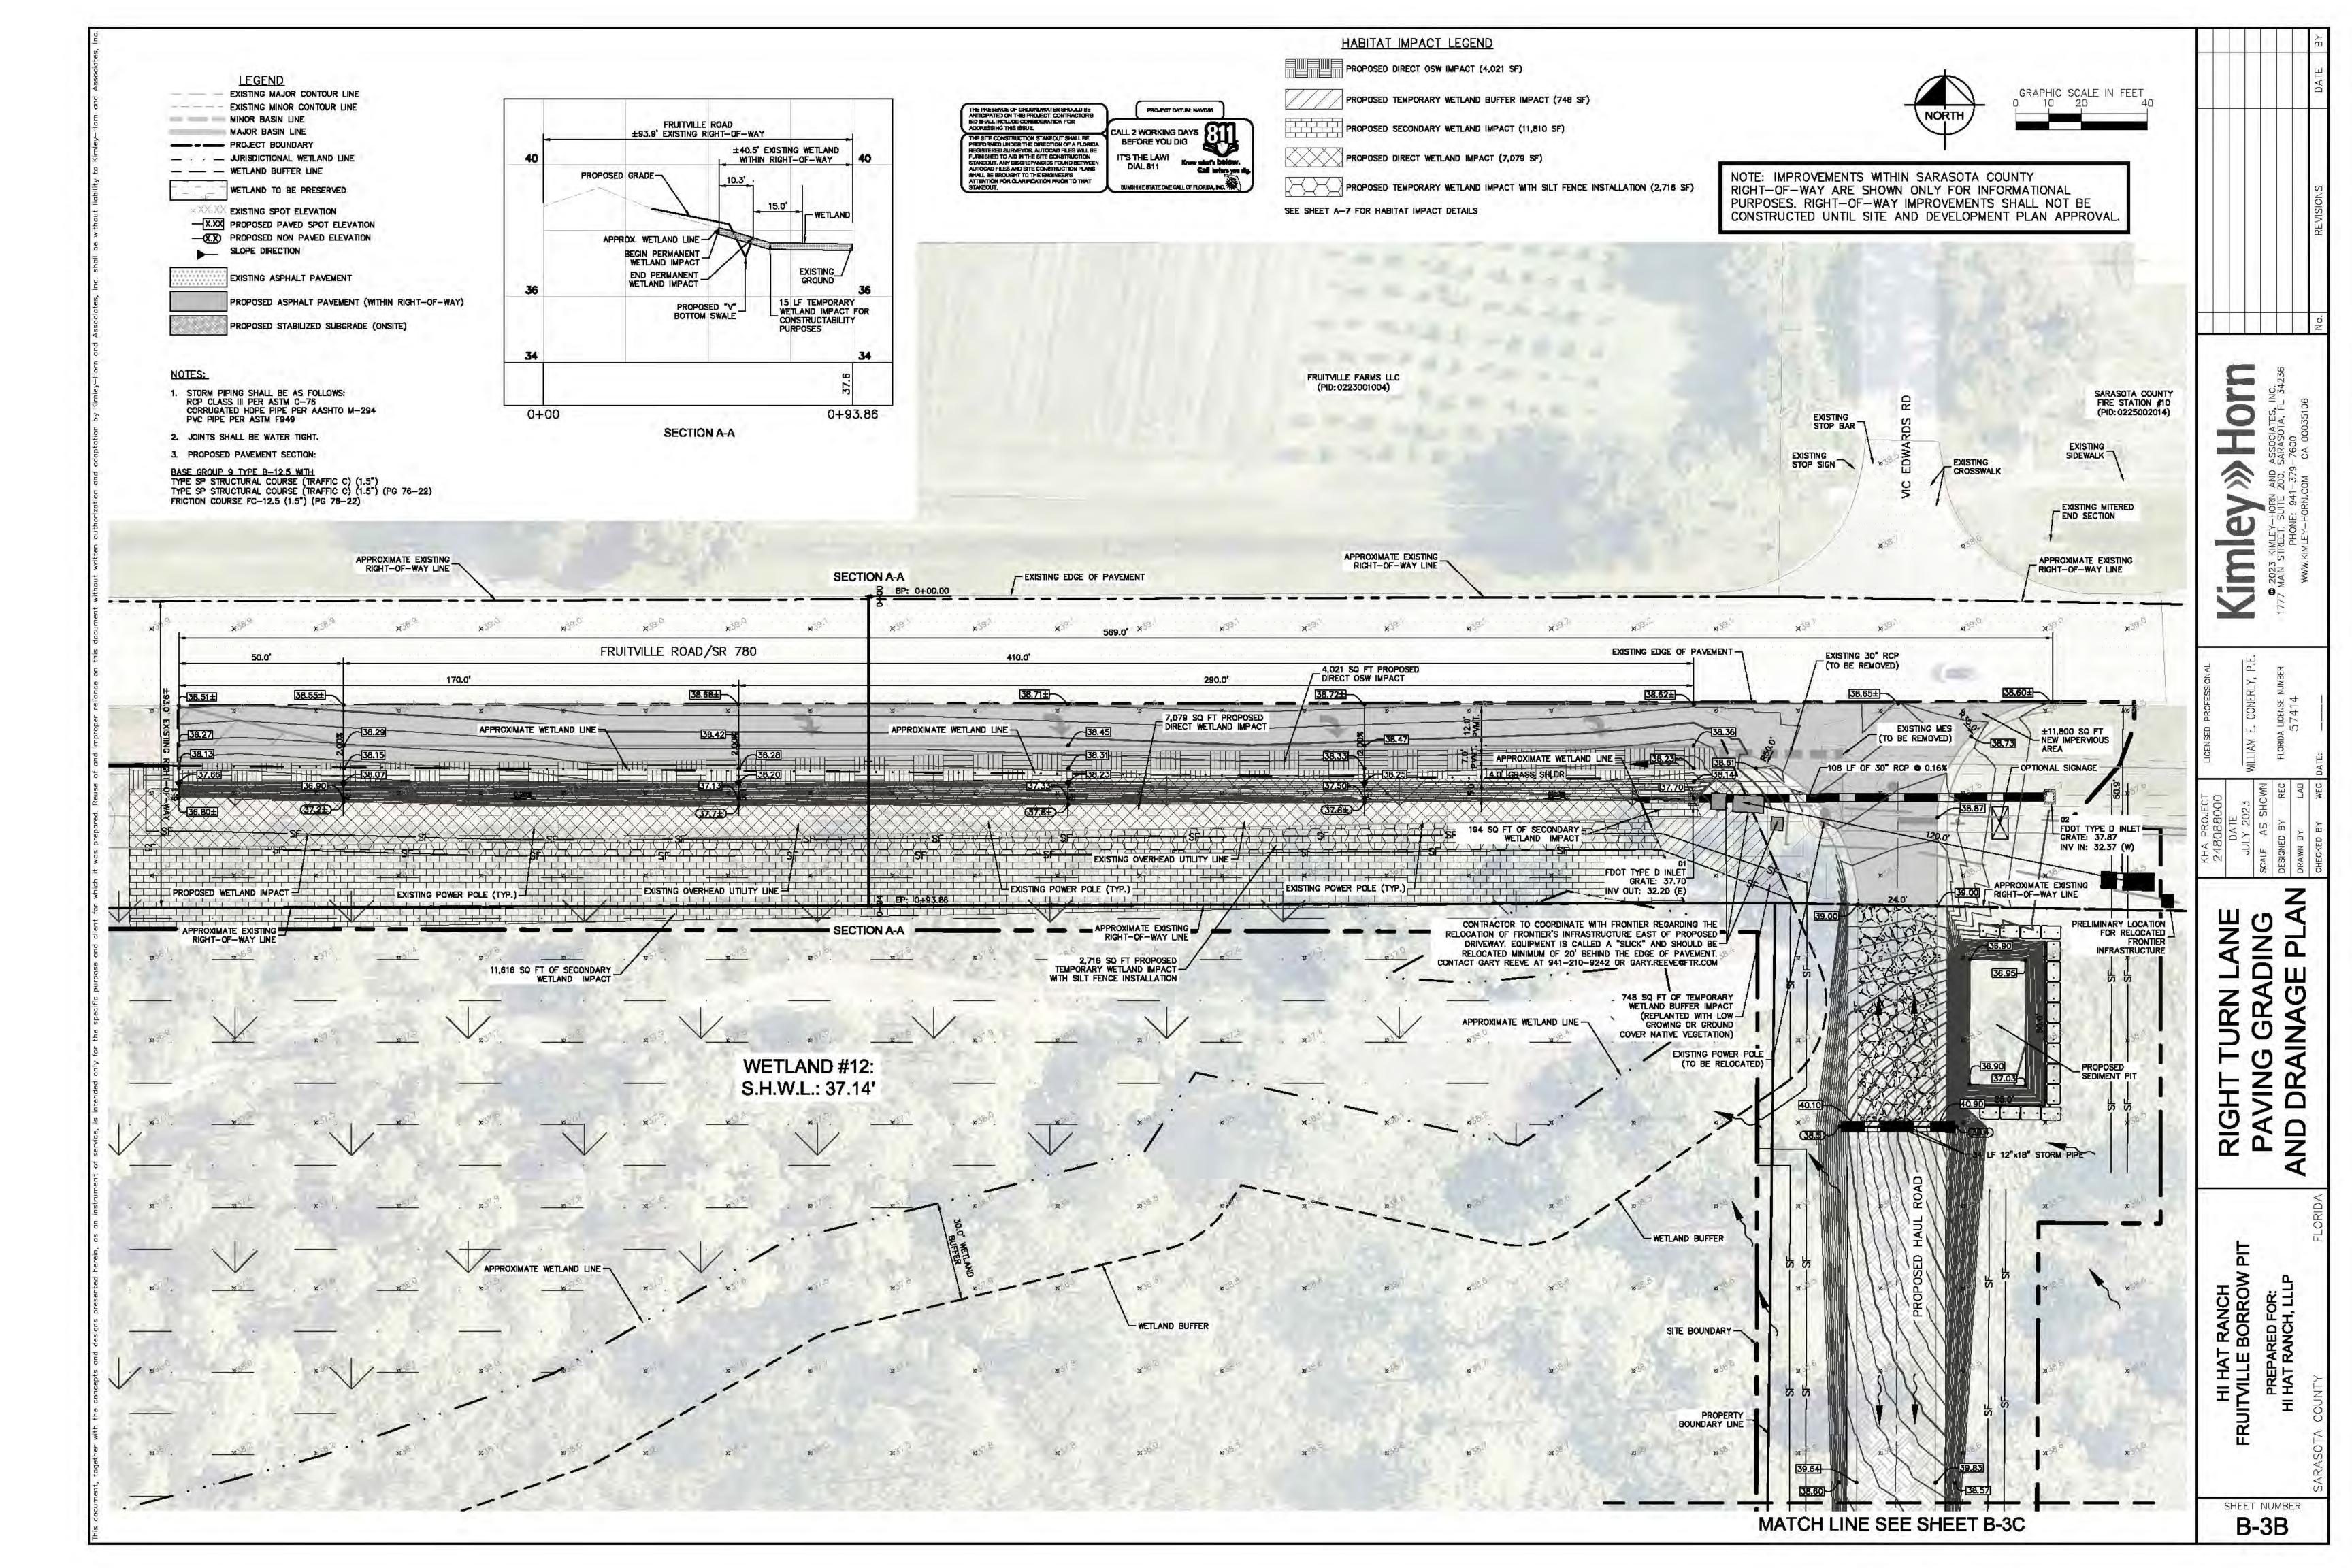
Kim.


SHEET NUMBER B-2


PREPARED FOR: I HAT RANCH, LLL


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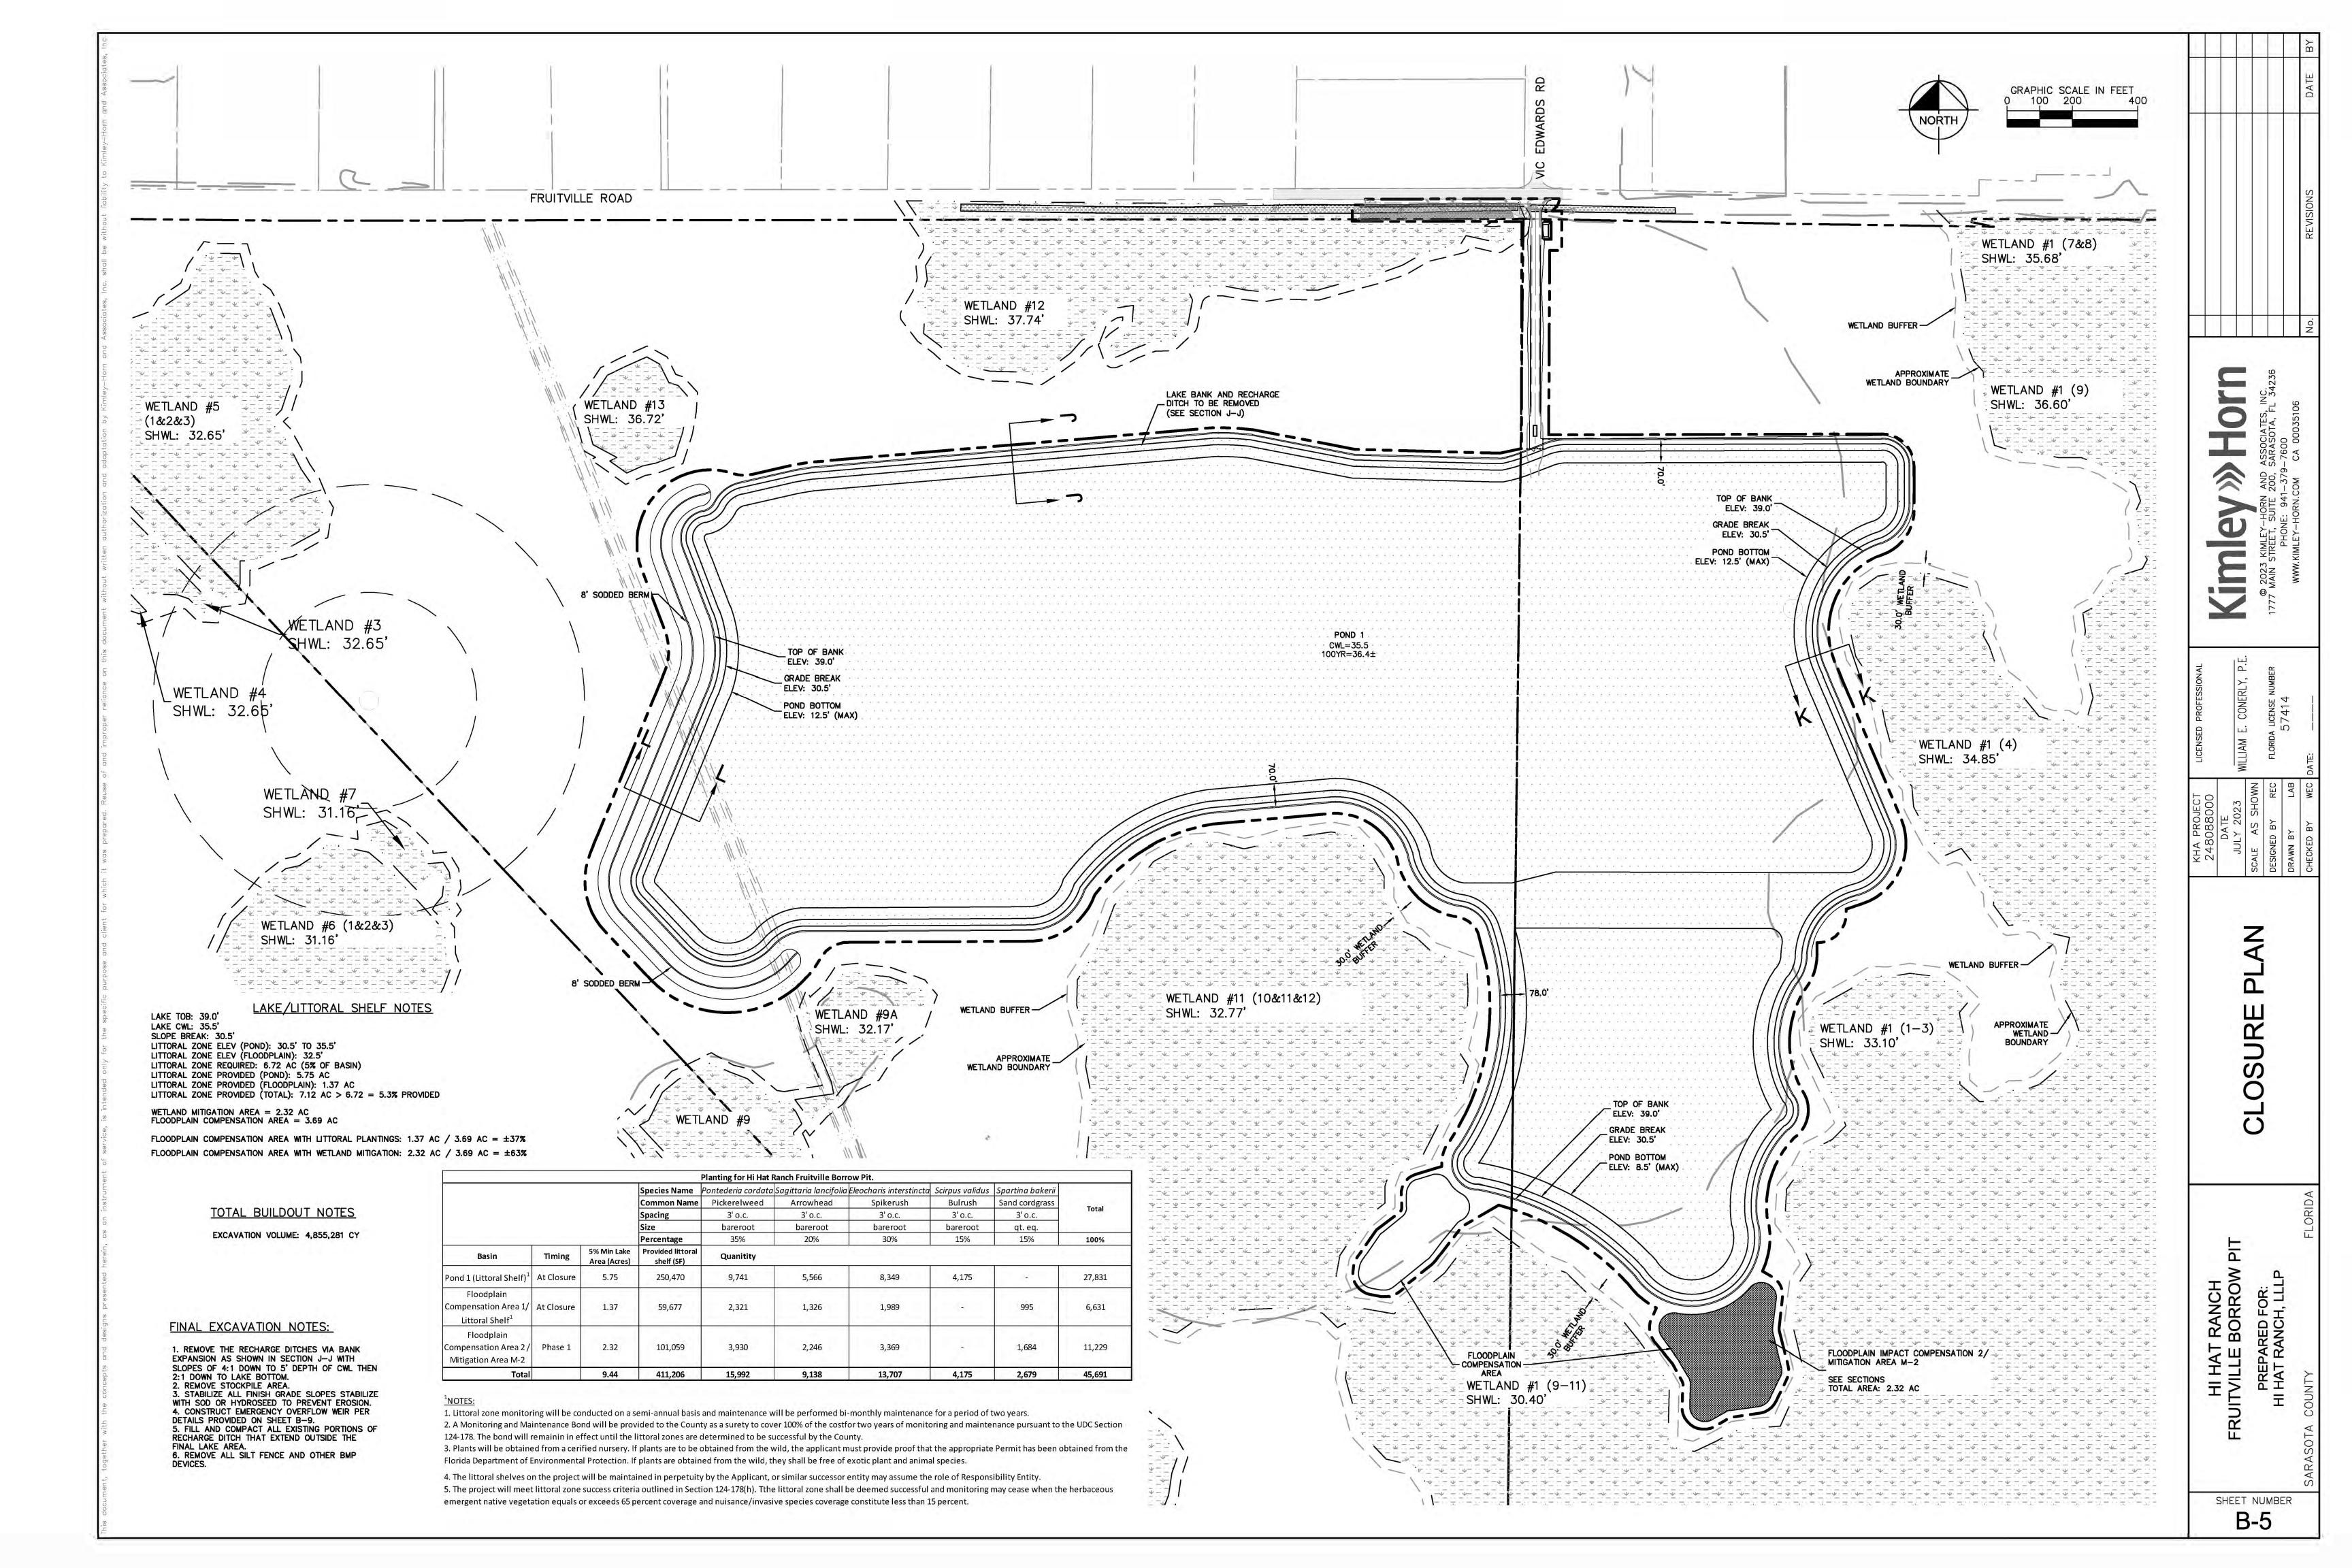





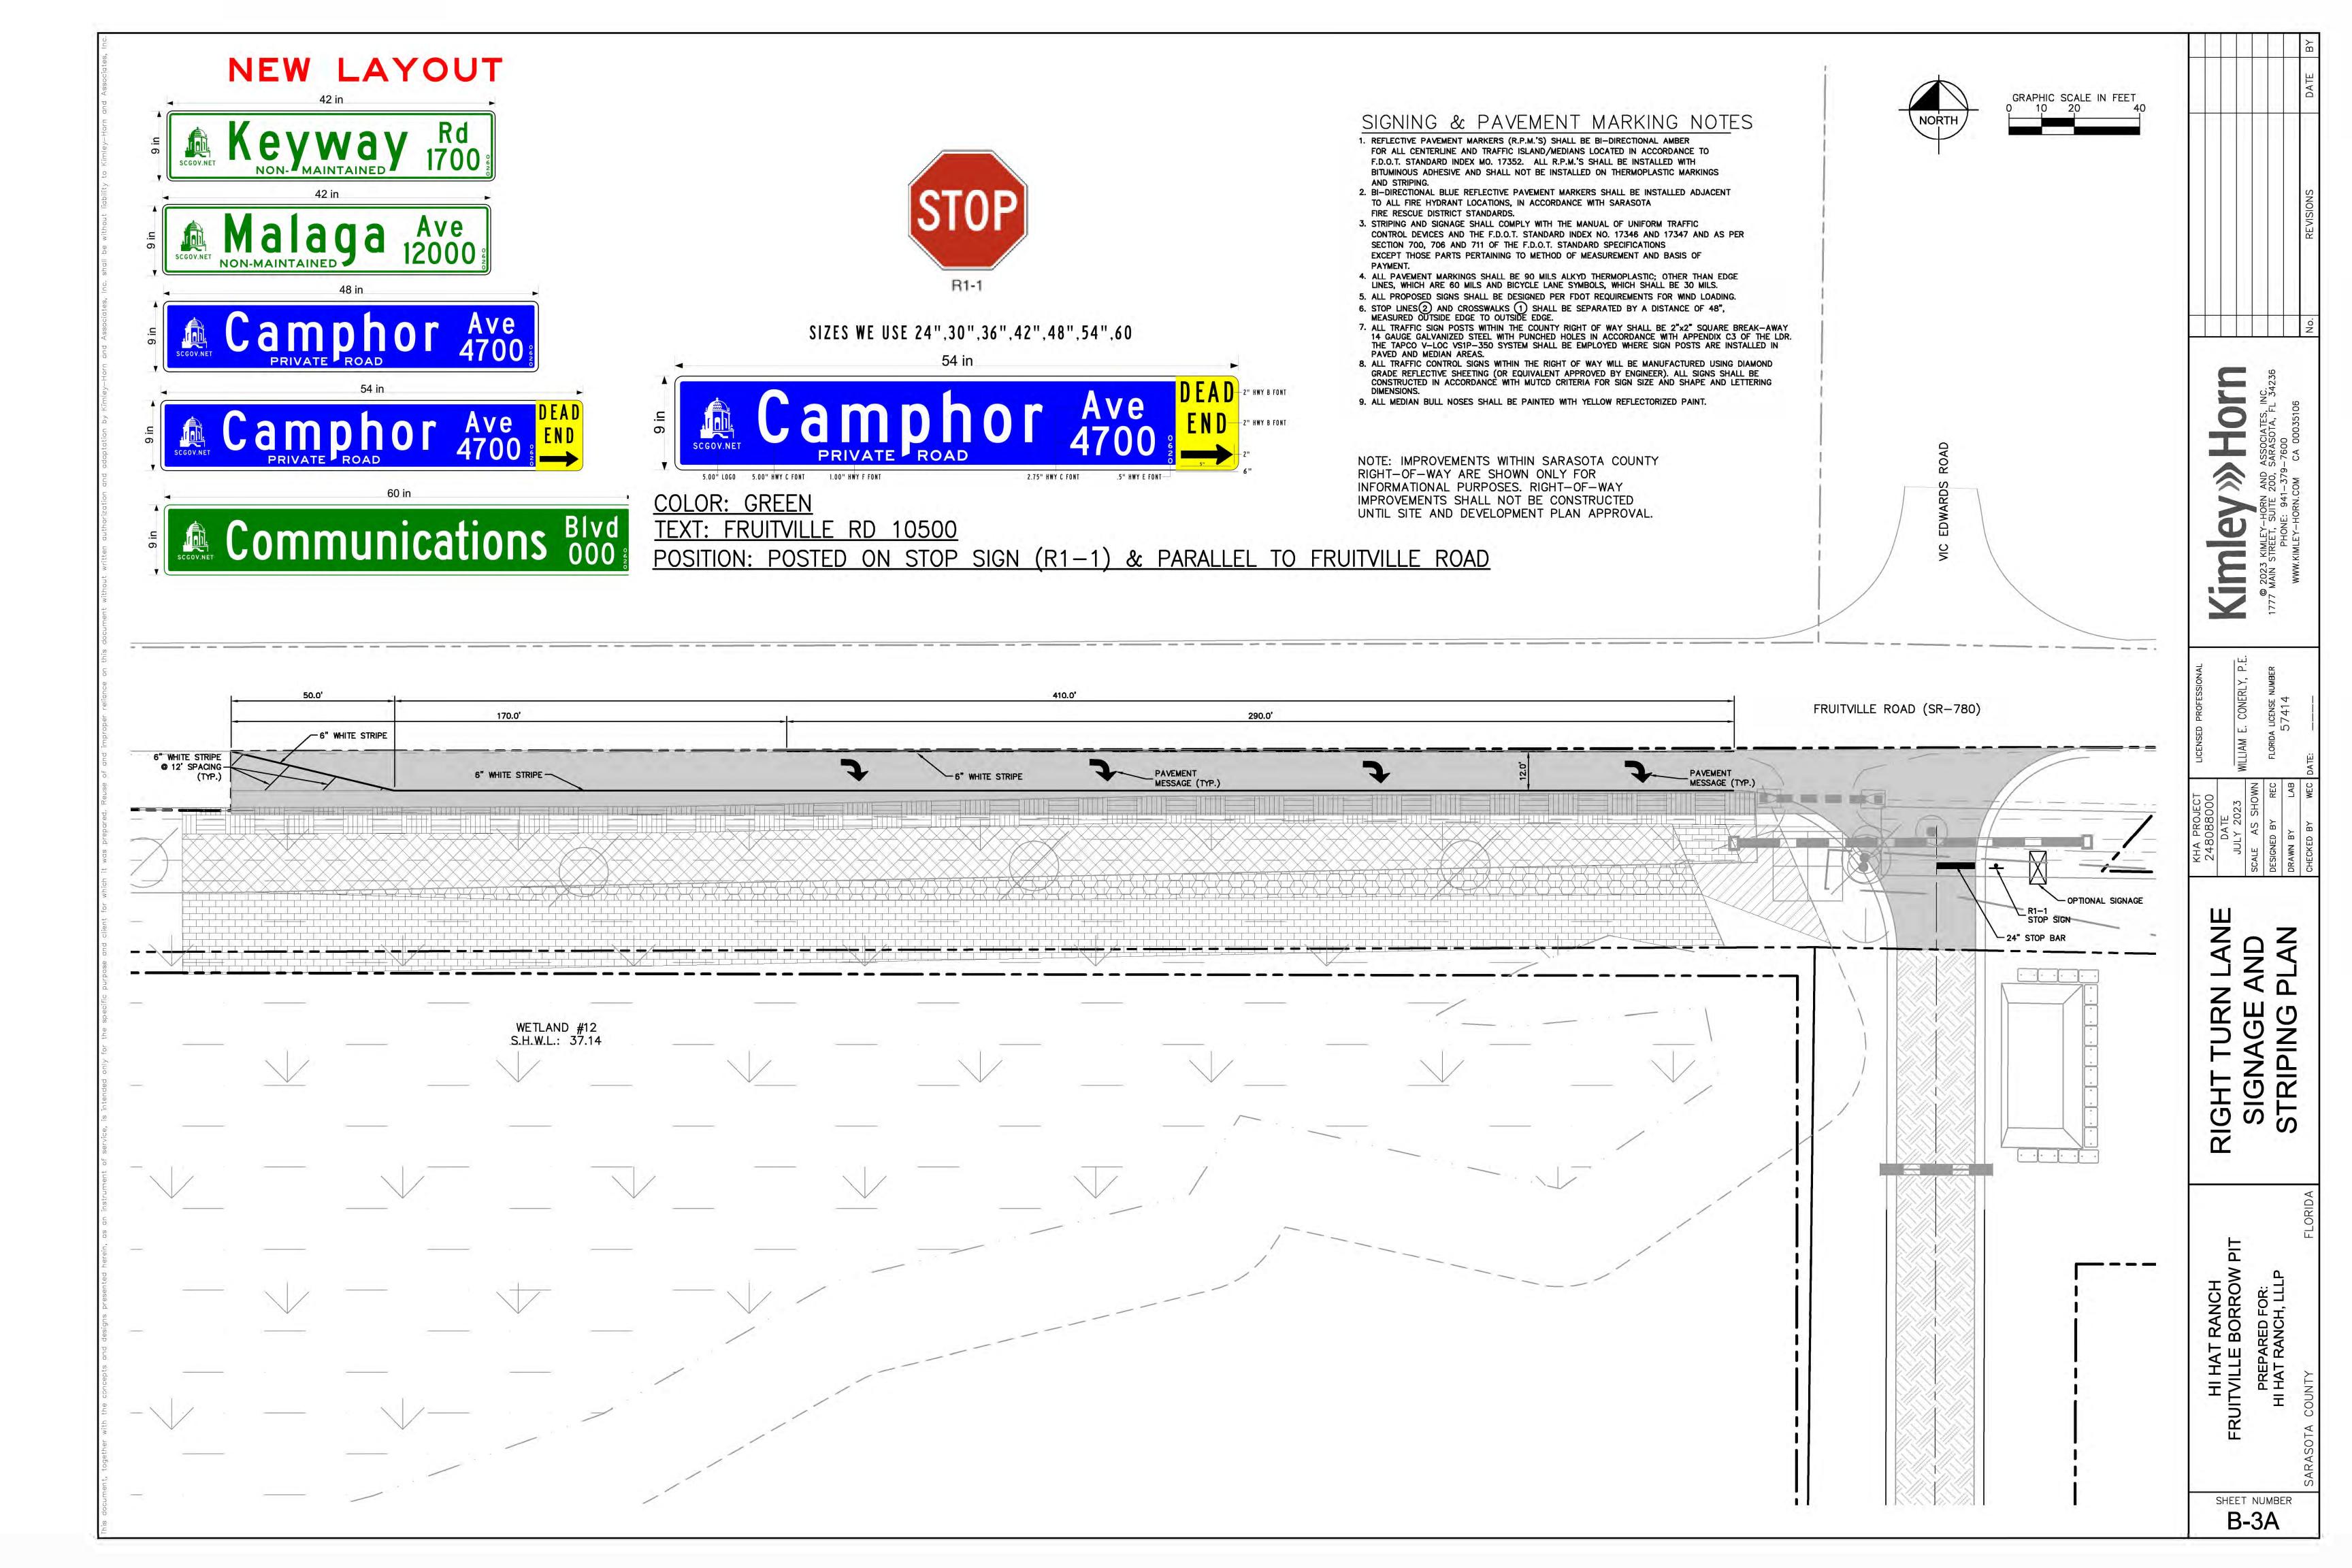


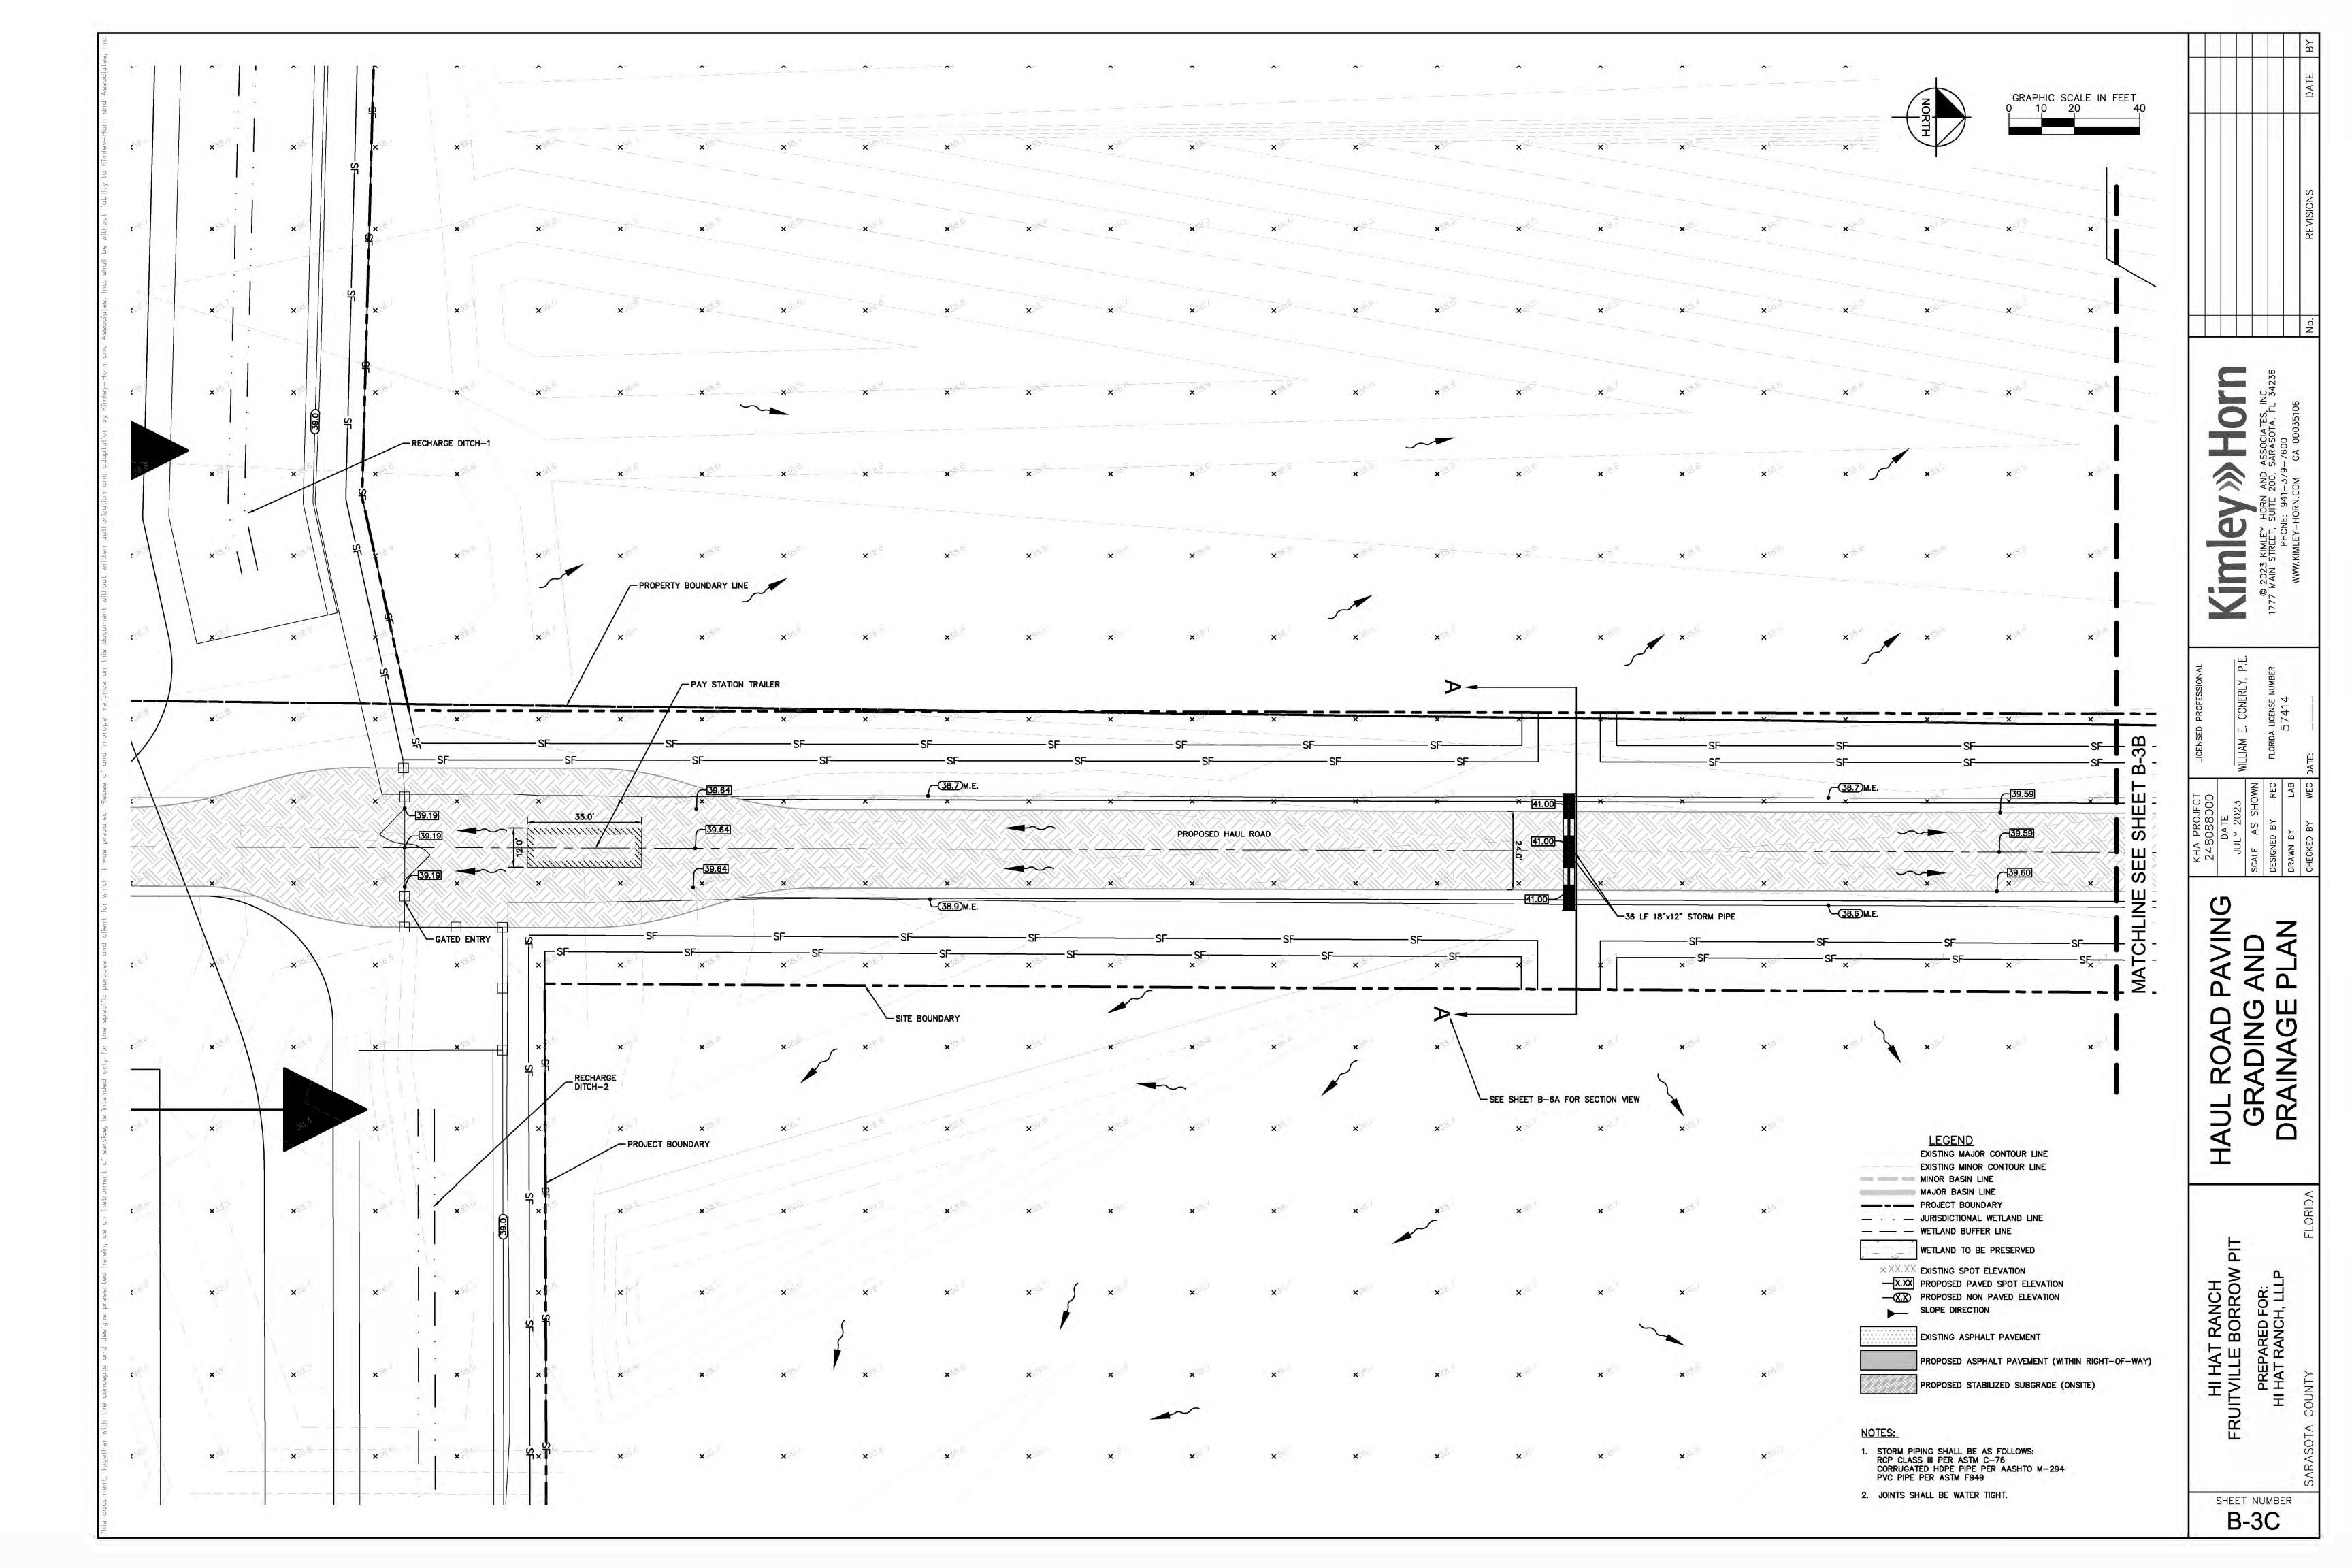


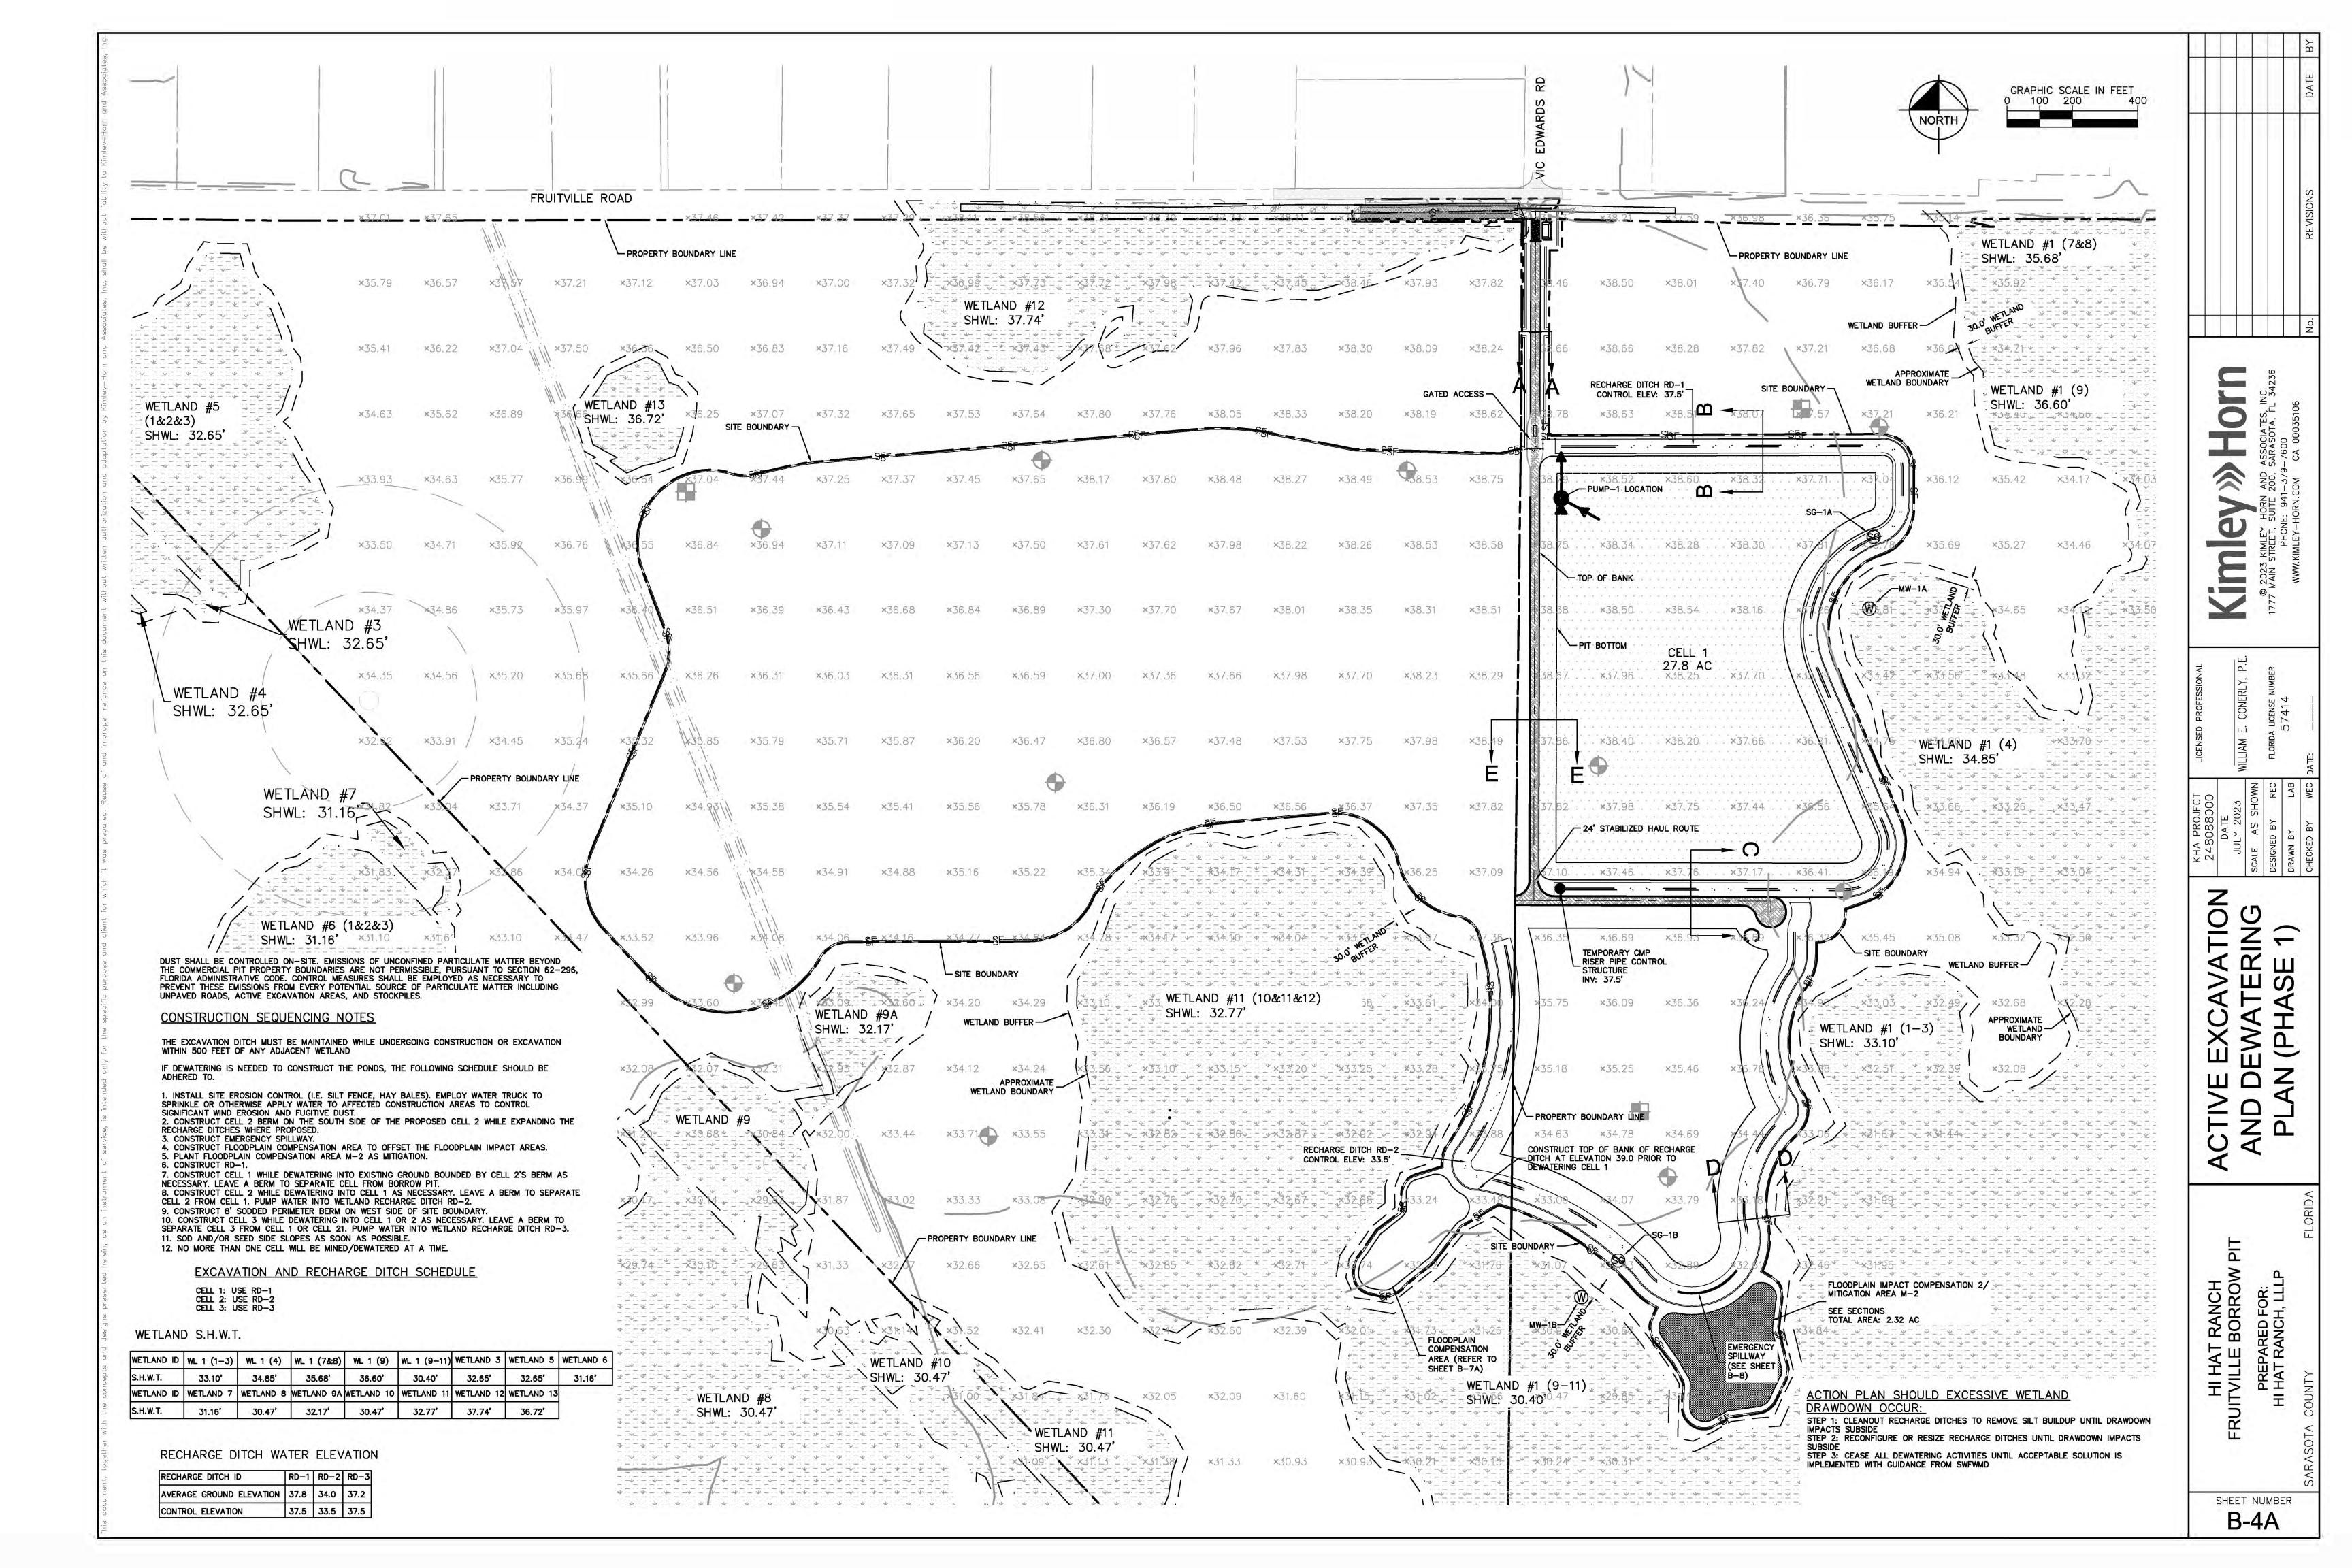


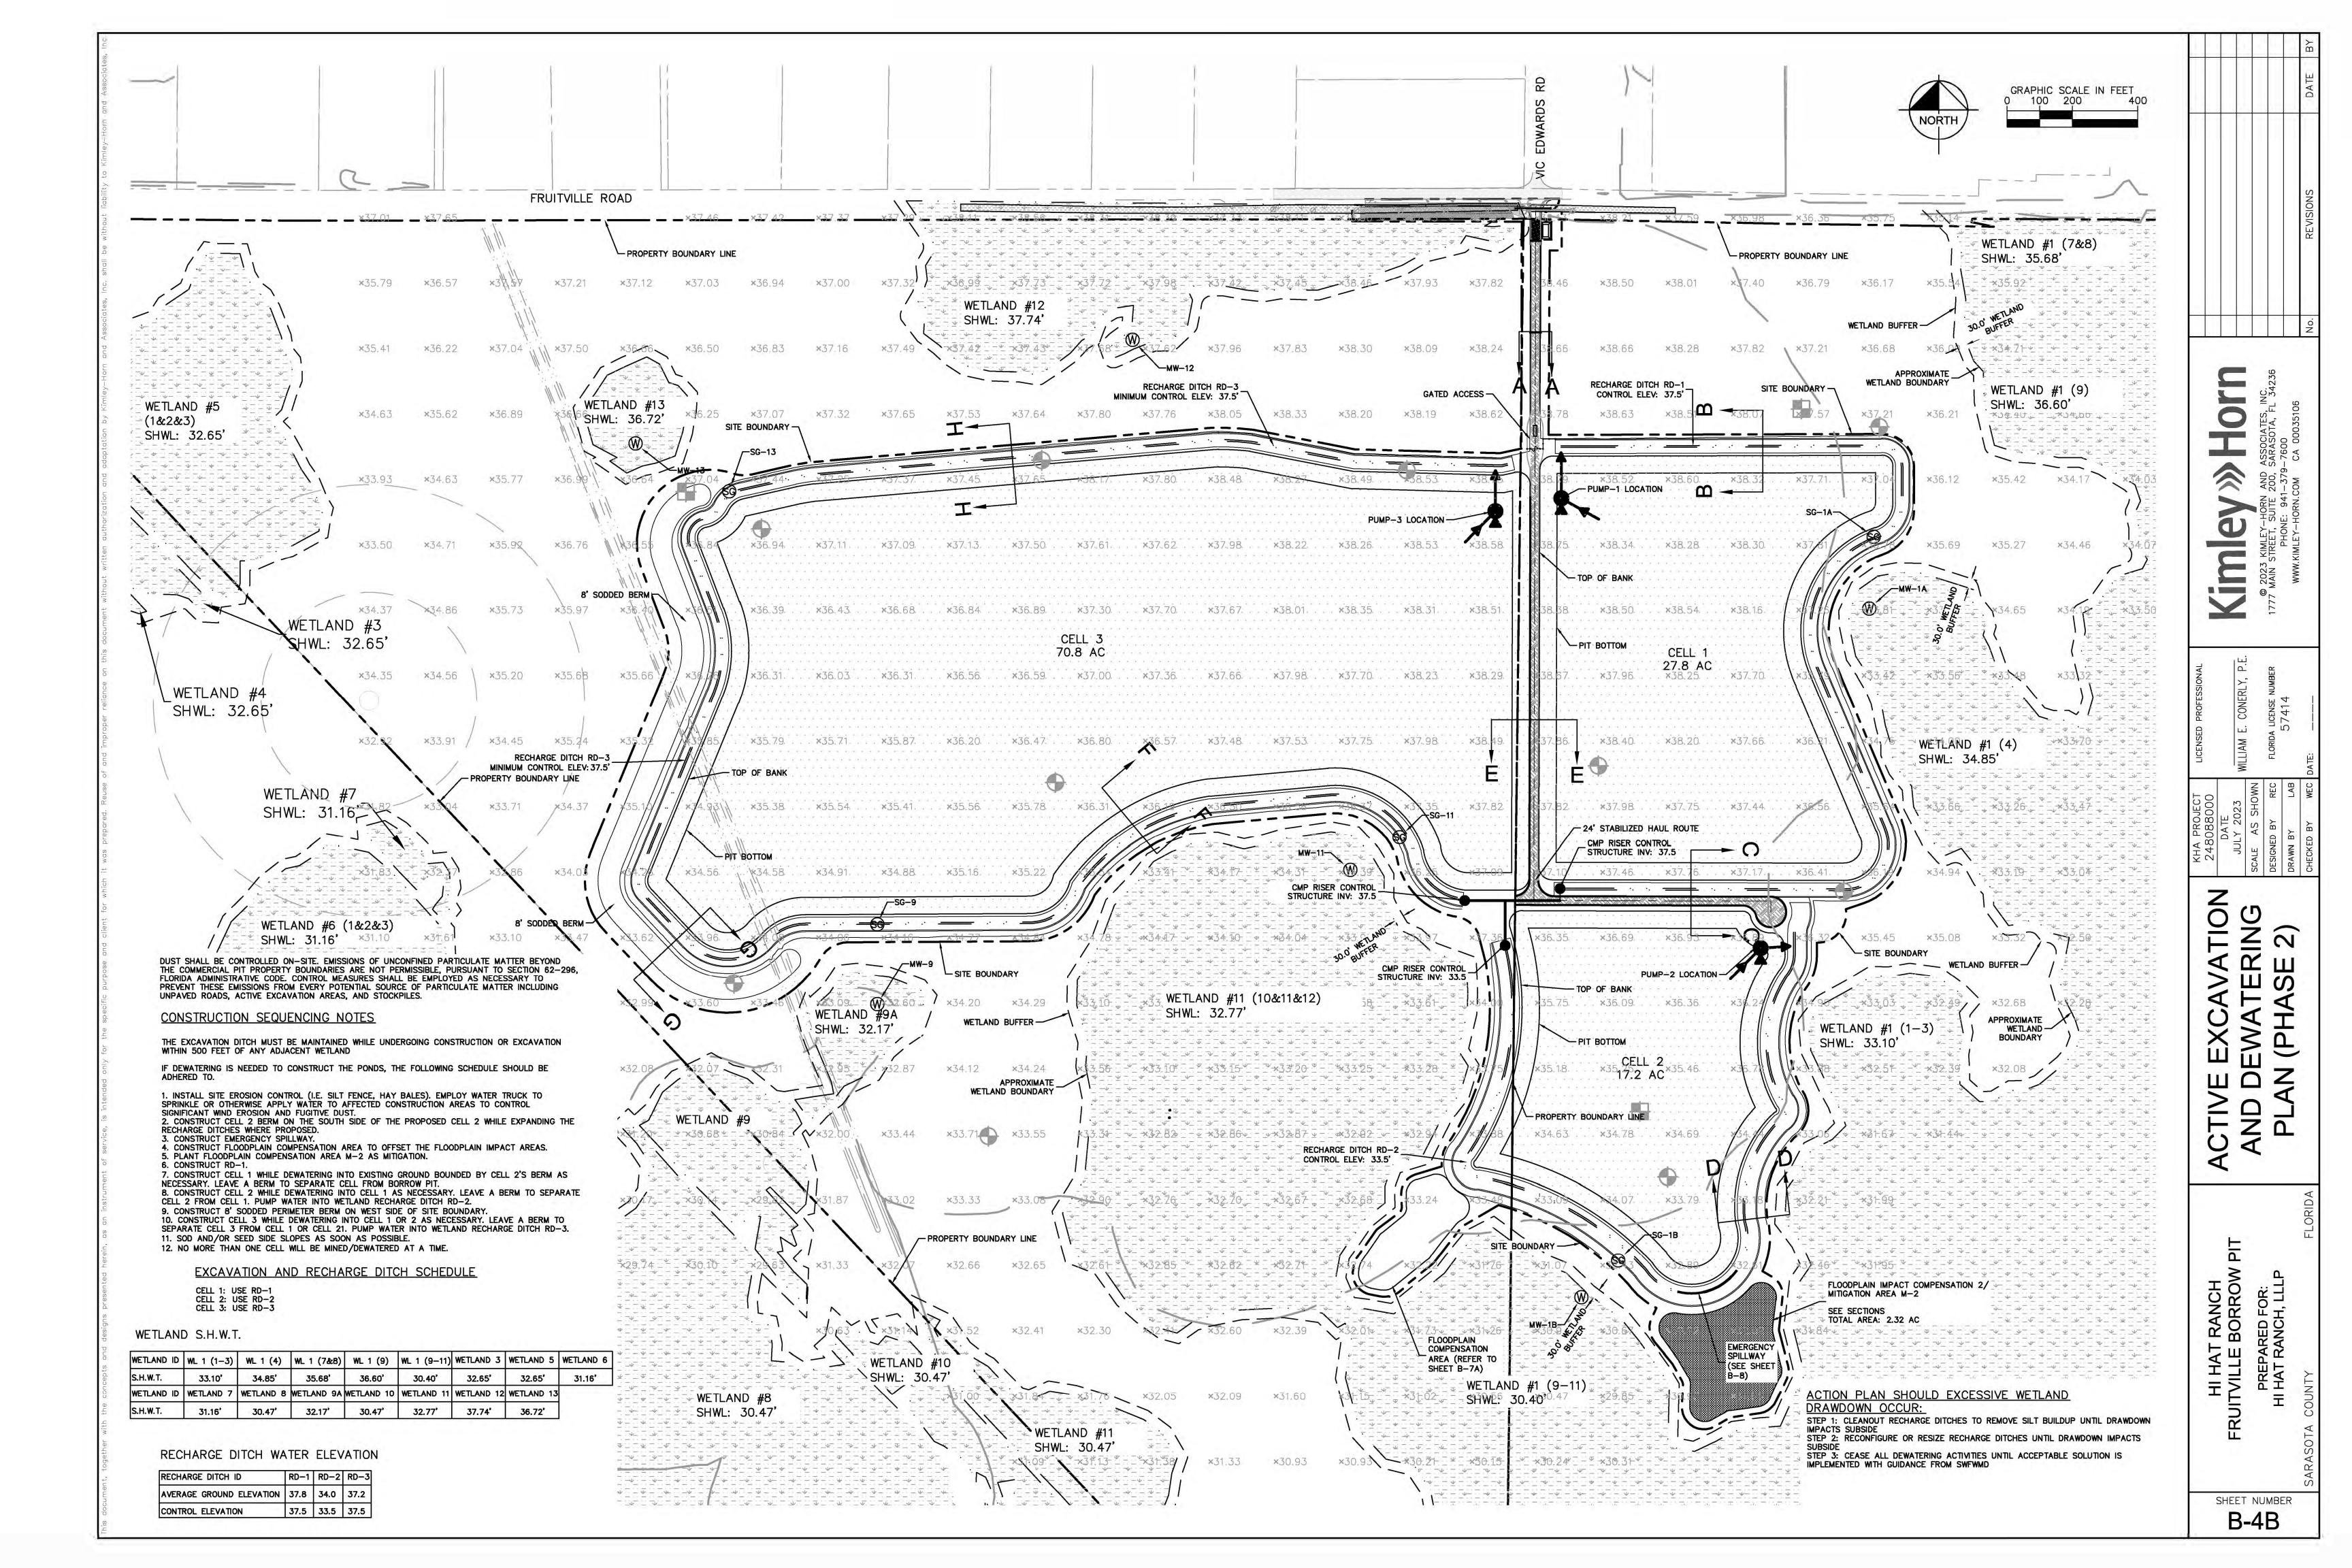


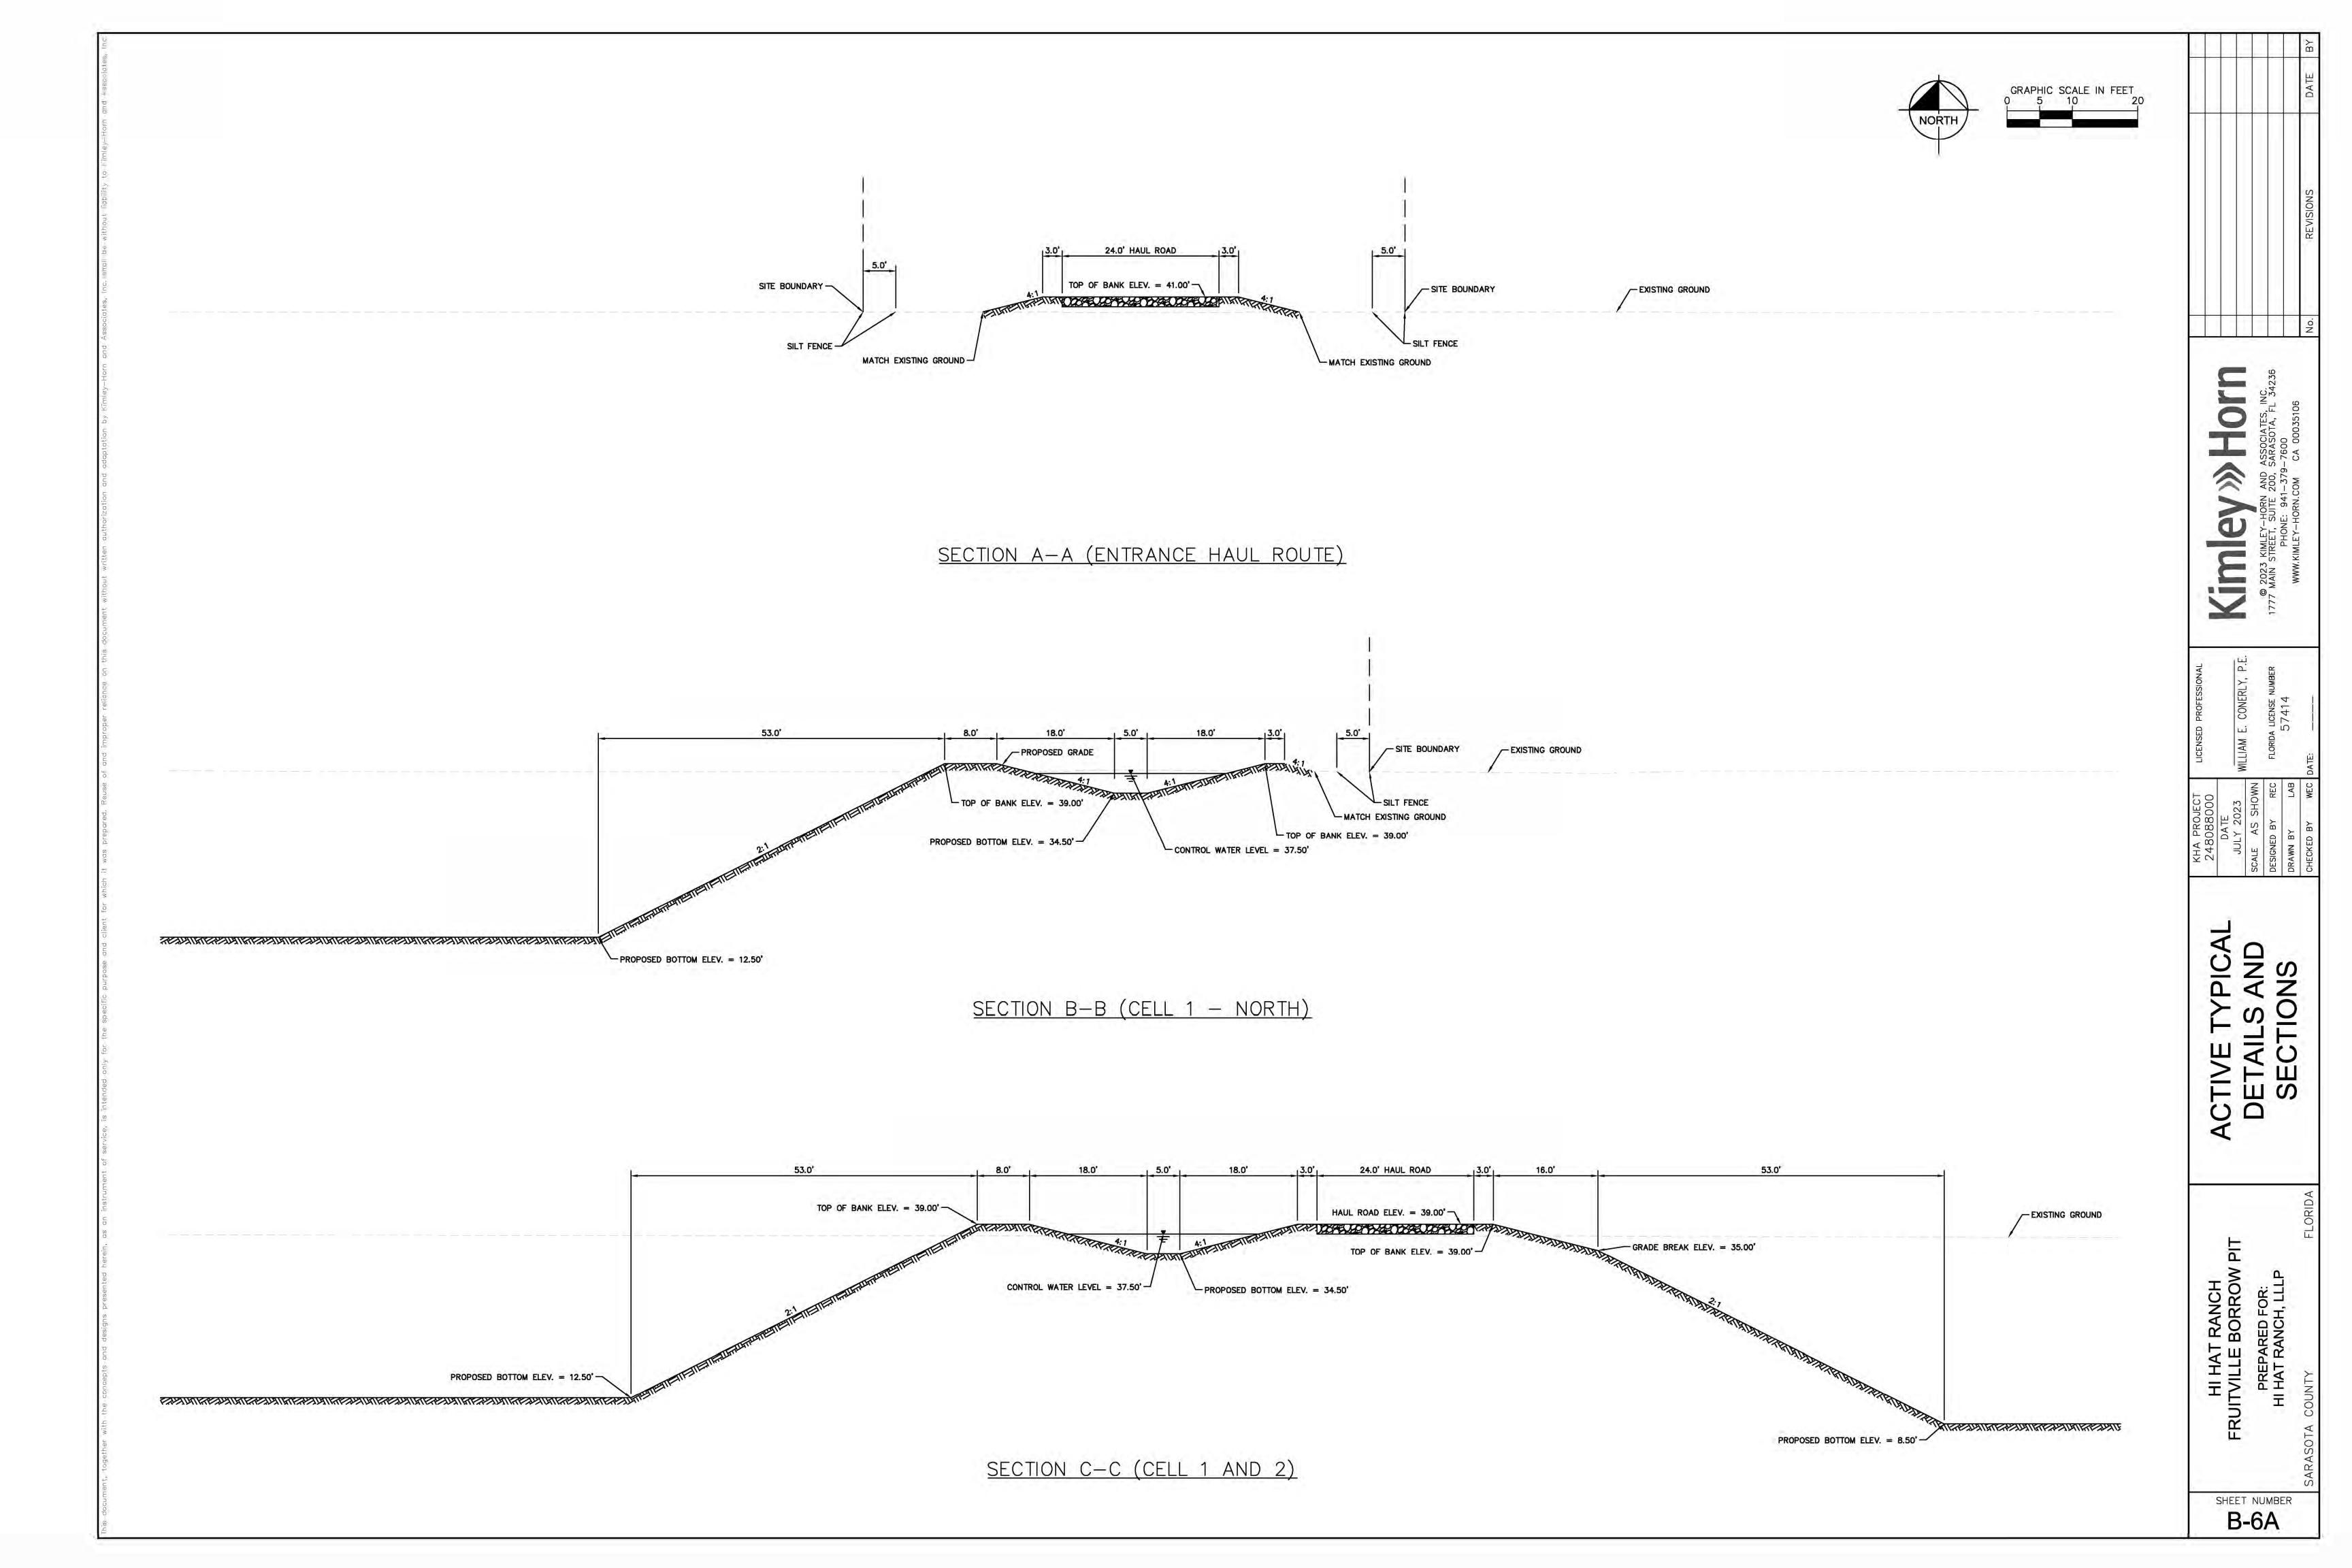

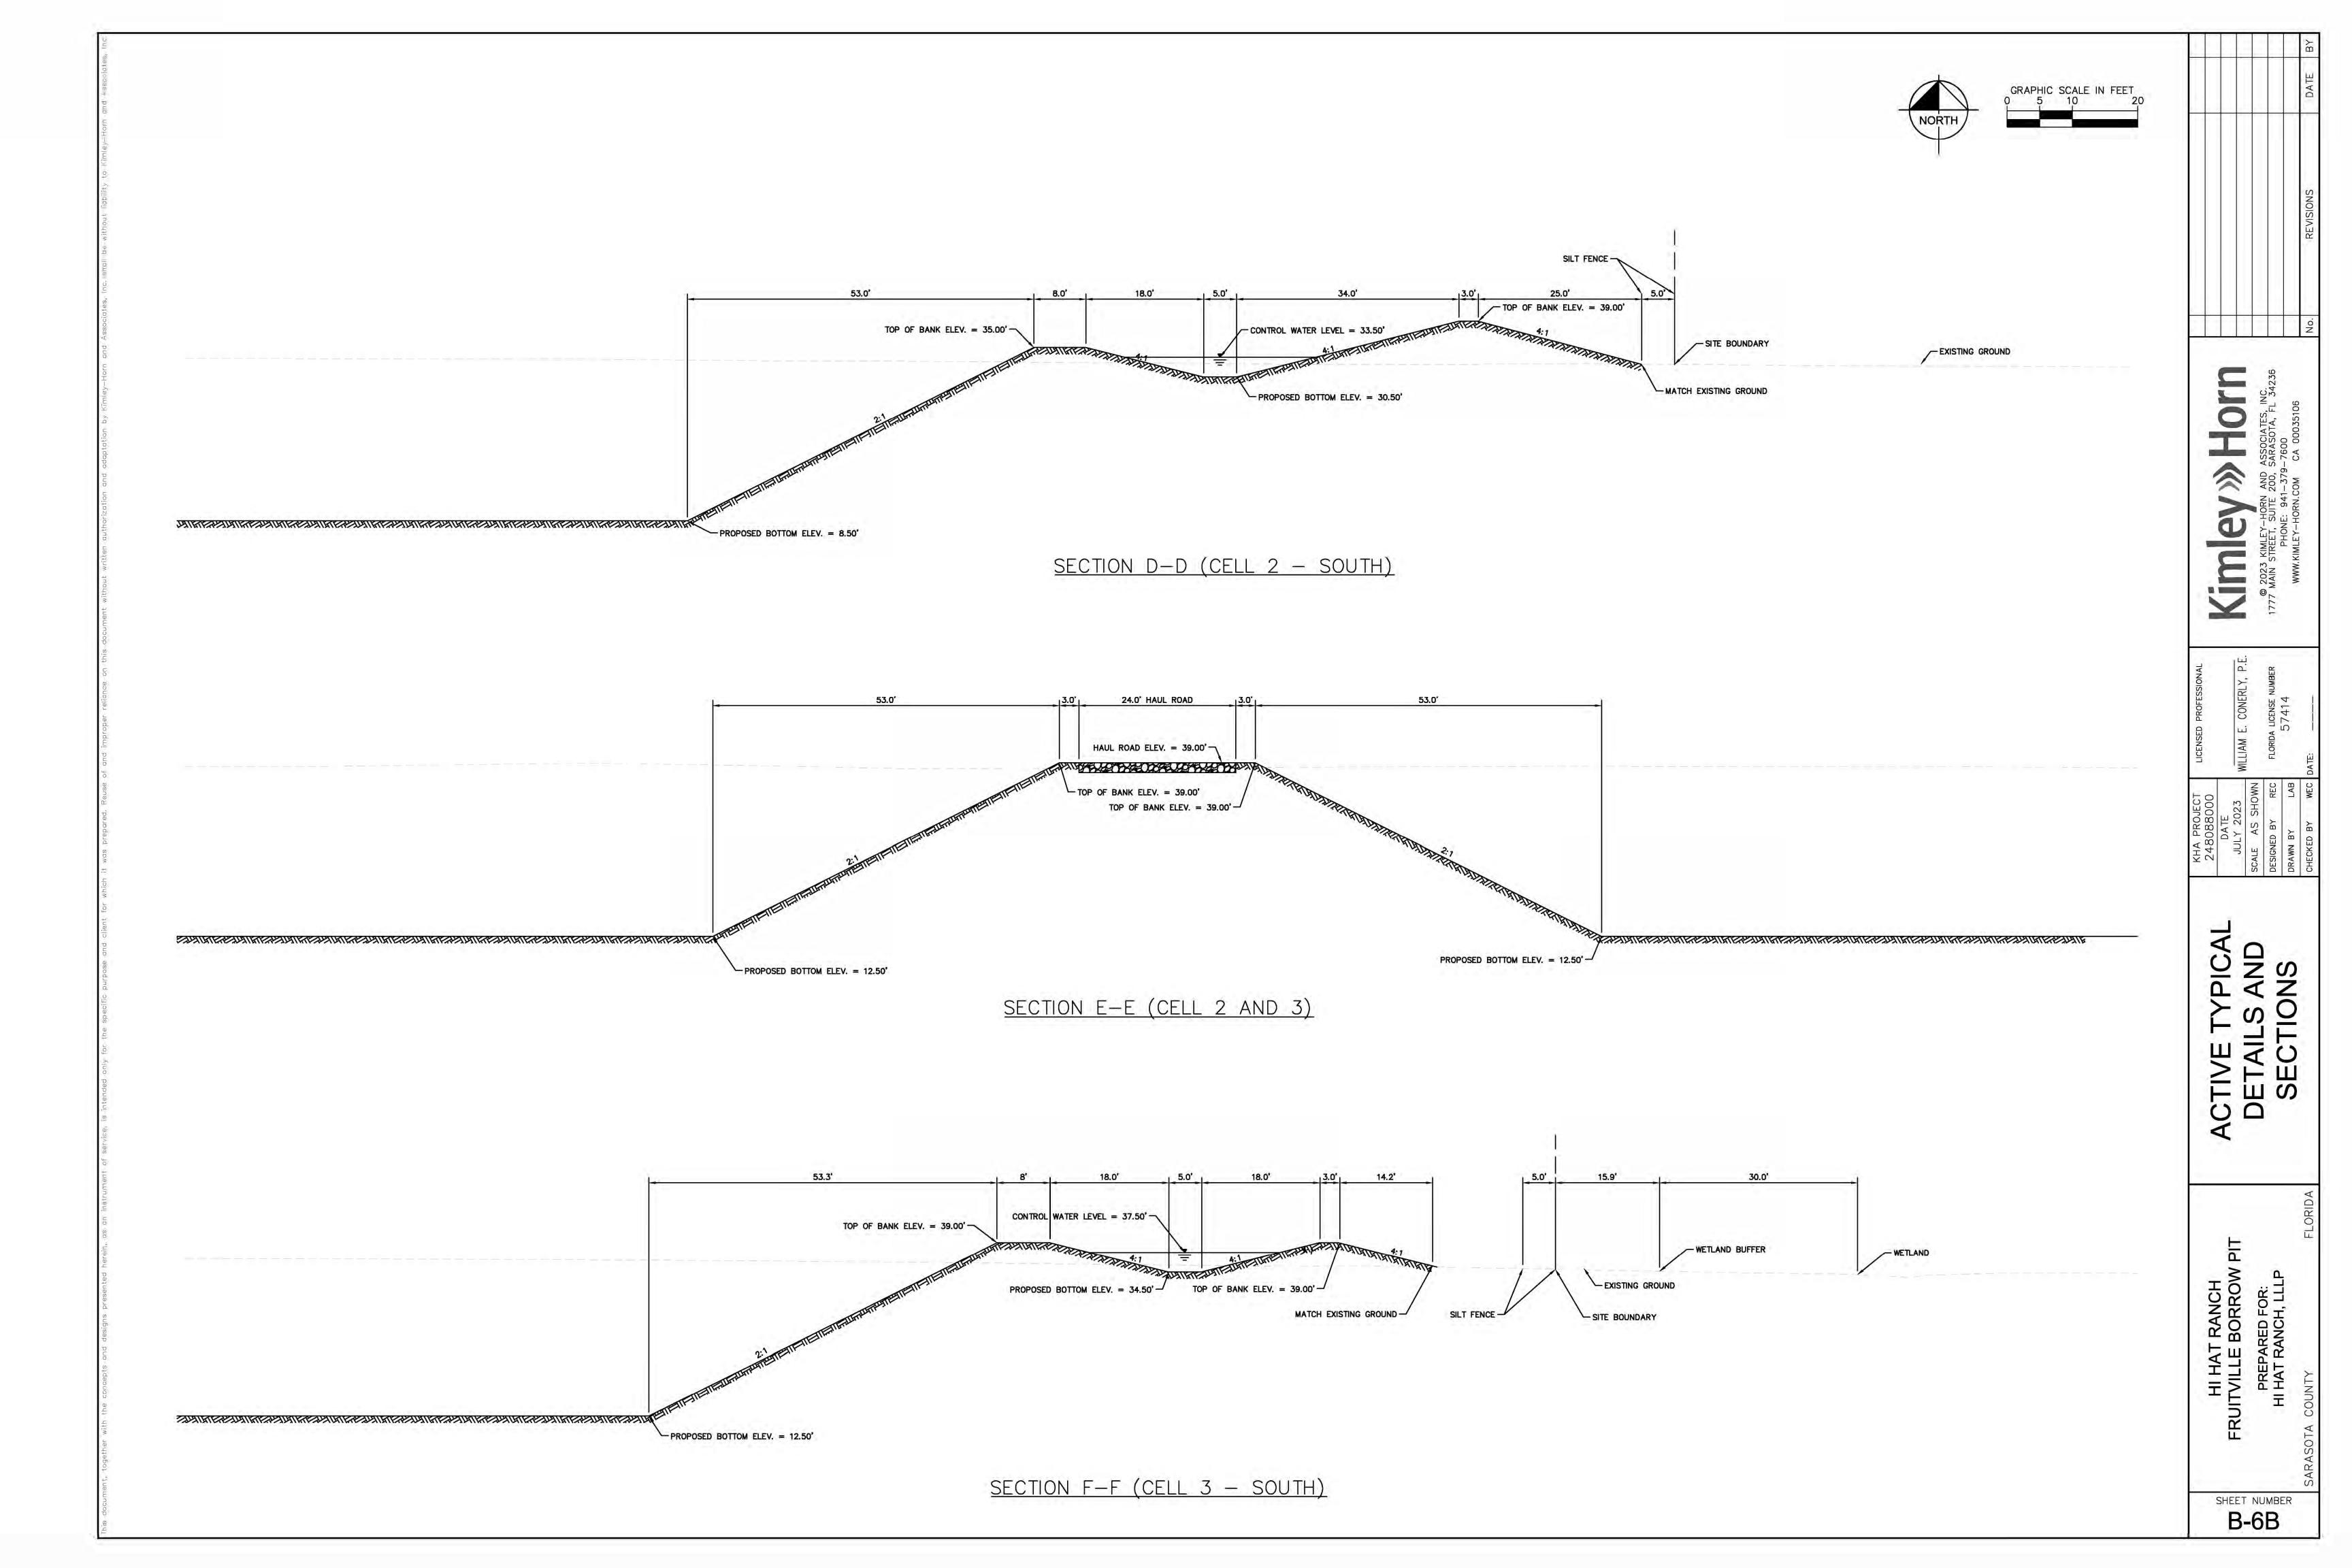

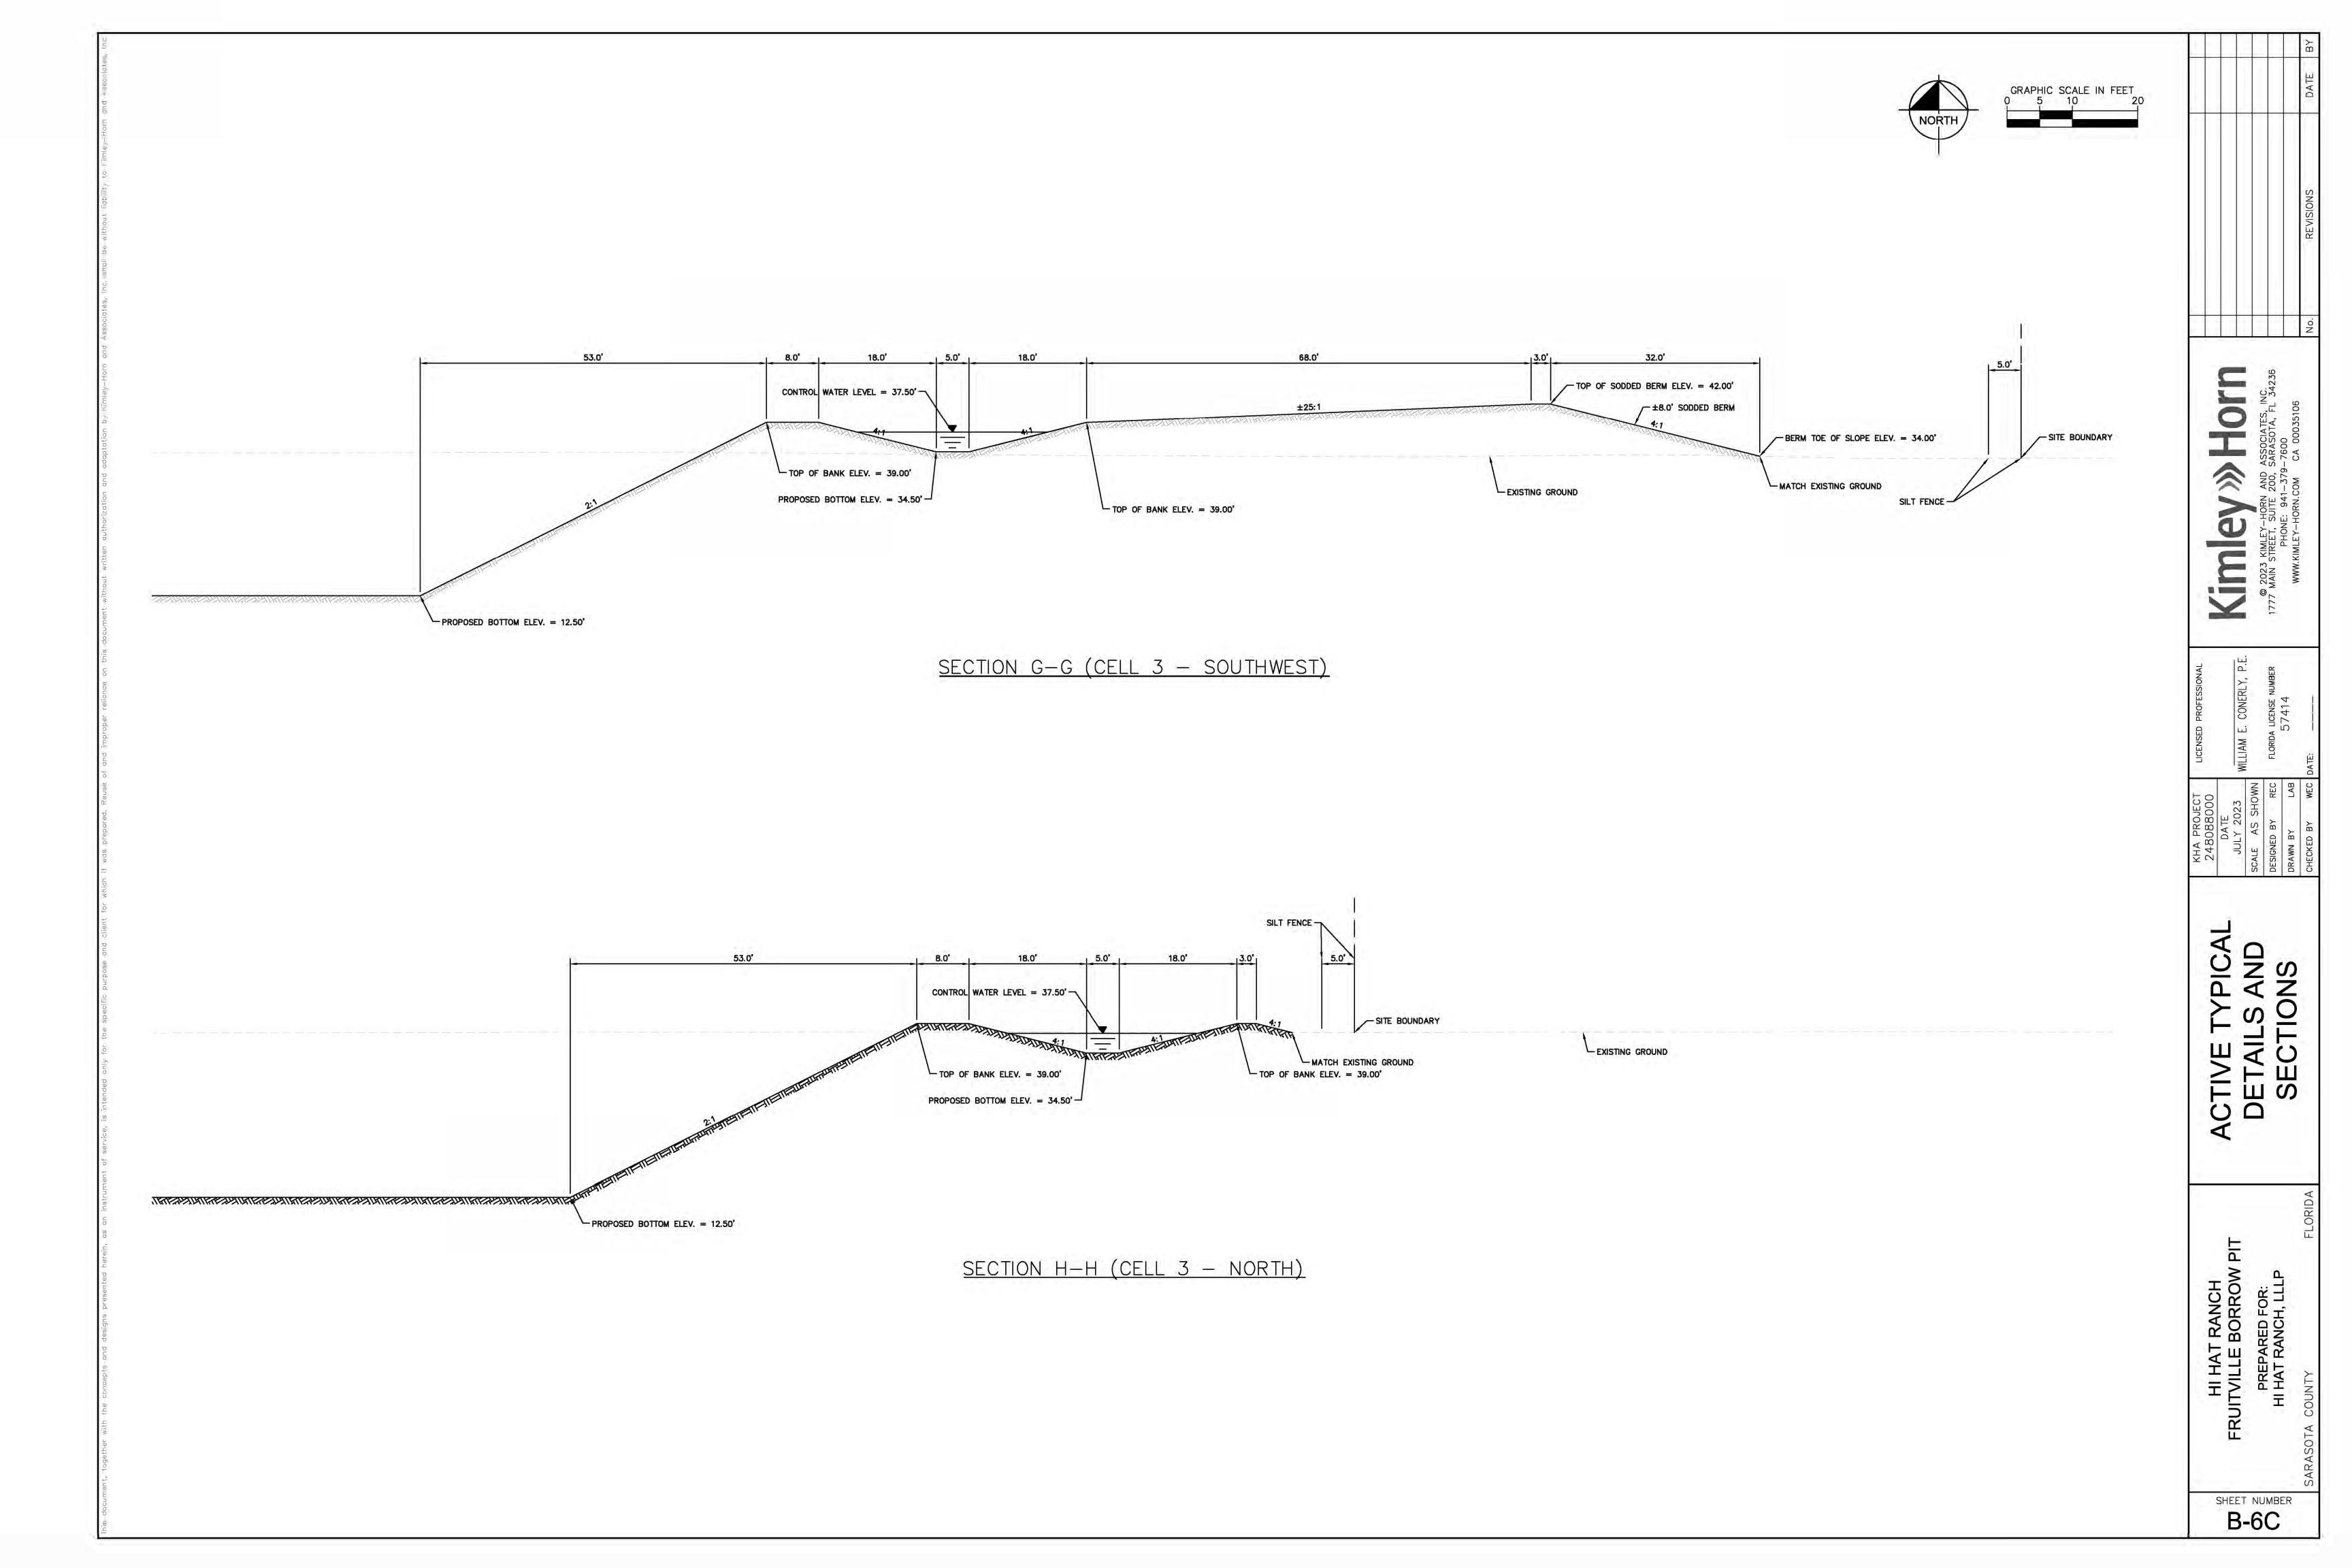

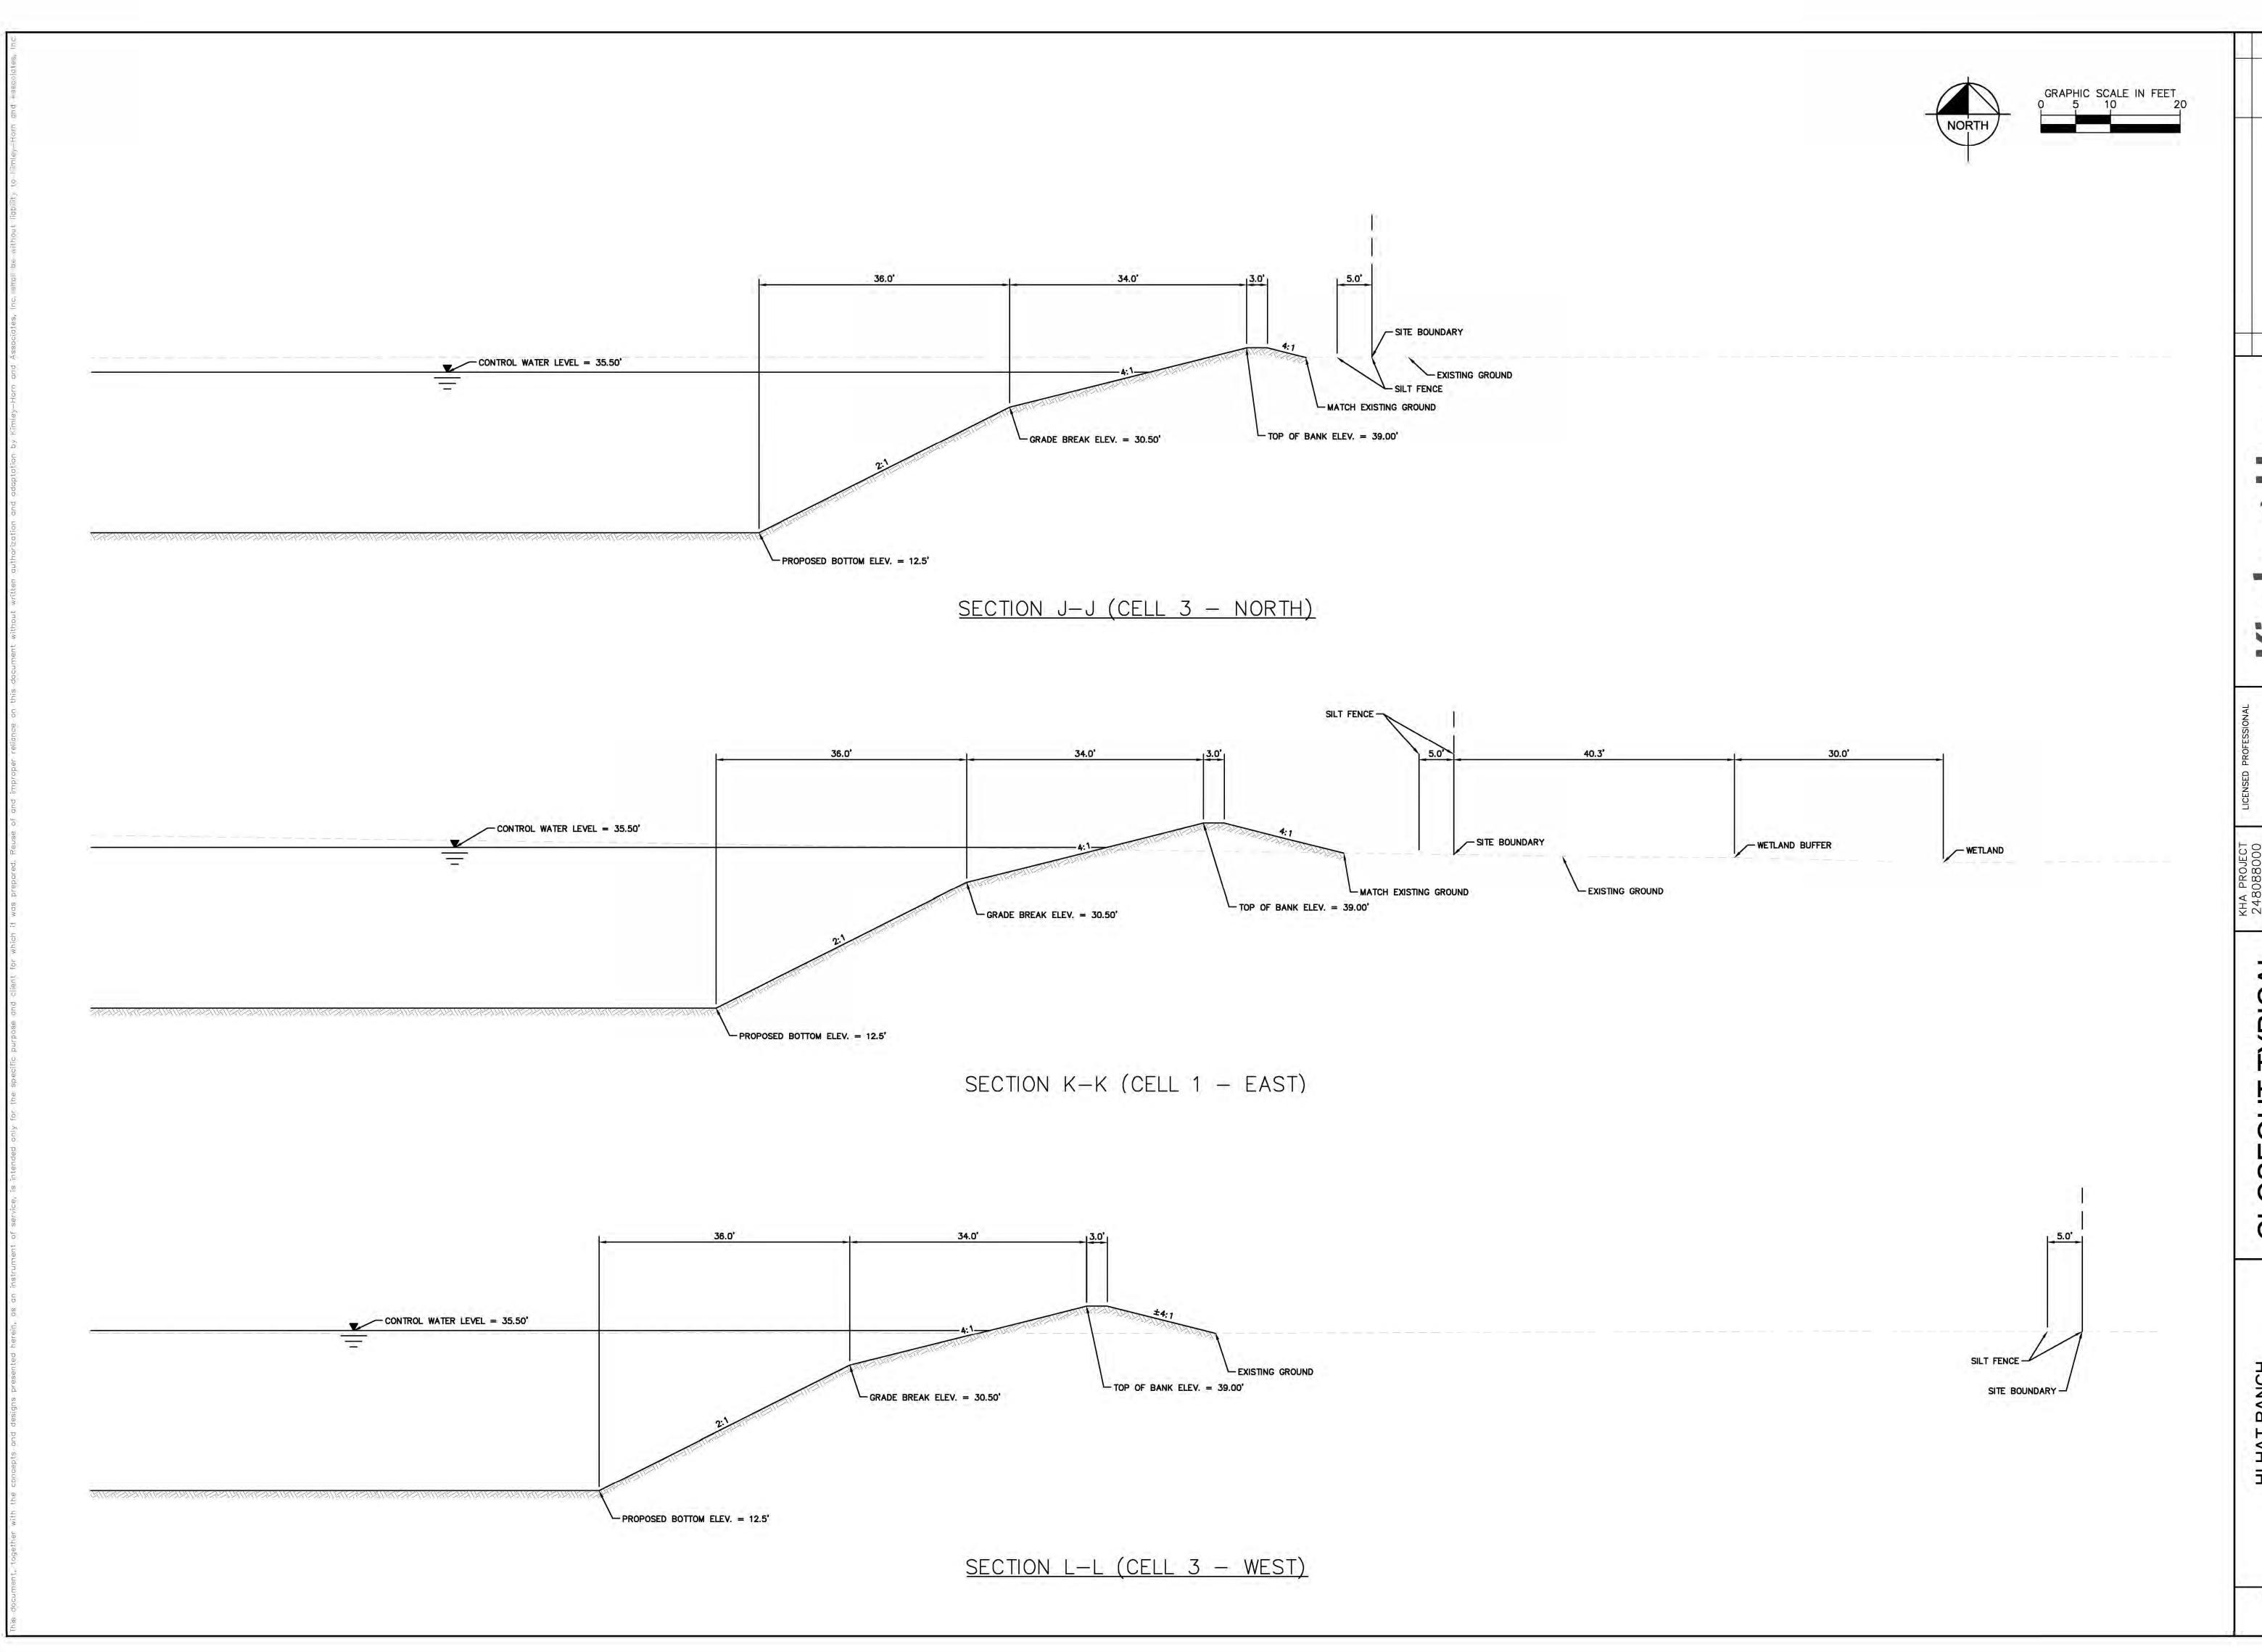

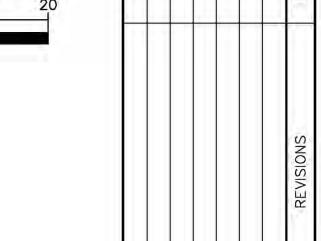

CONERLY, P.E.


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DATE
JULY 2023
WILLIAM E. CONERLY,
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SIGNED BY REC
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DETAILS AND
SECTIONS

HI HAT RANCH
FRUITVILLE BORROW PIT
PREPARED FOR:
HI HAT RANCH, LLLP

SHEET NUMBER **B-6D**



PREPARED FOR: HI HAT RANCH, LLLP

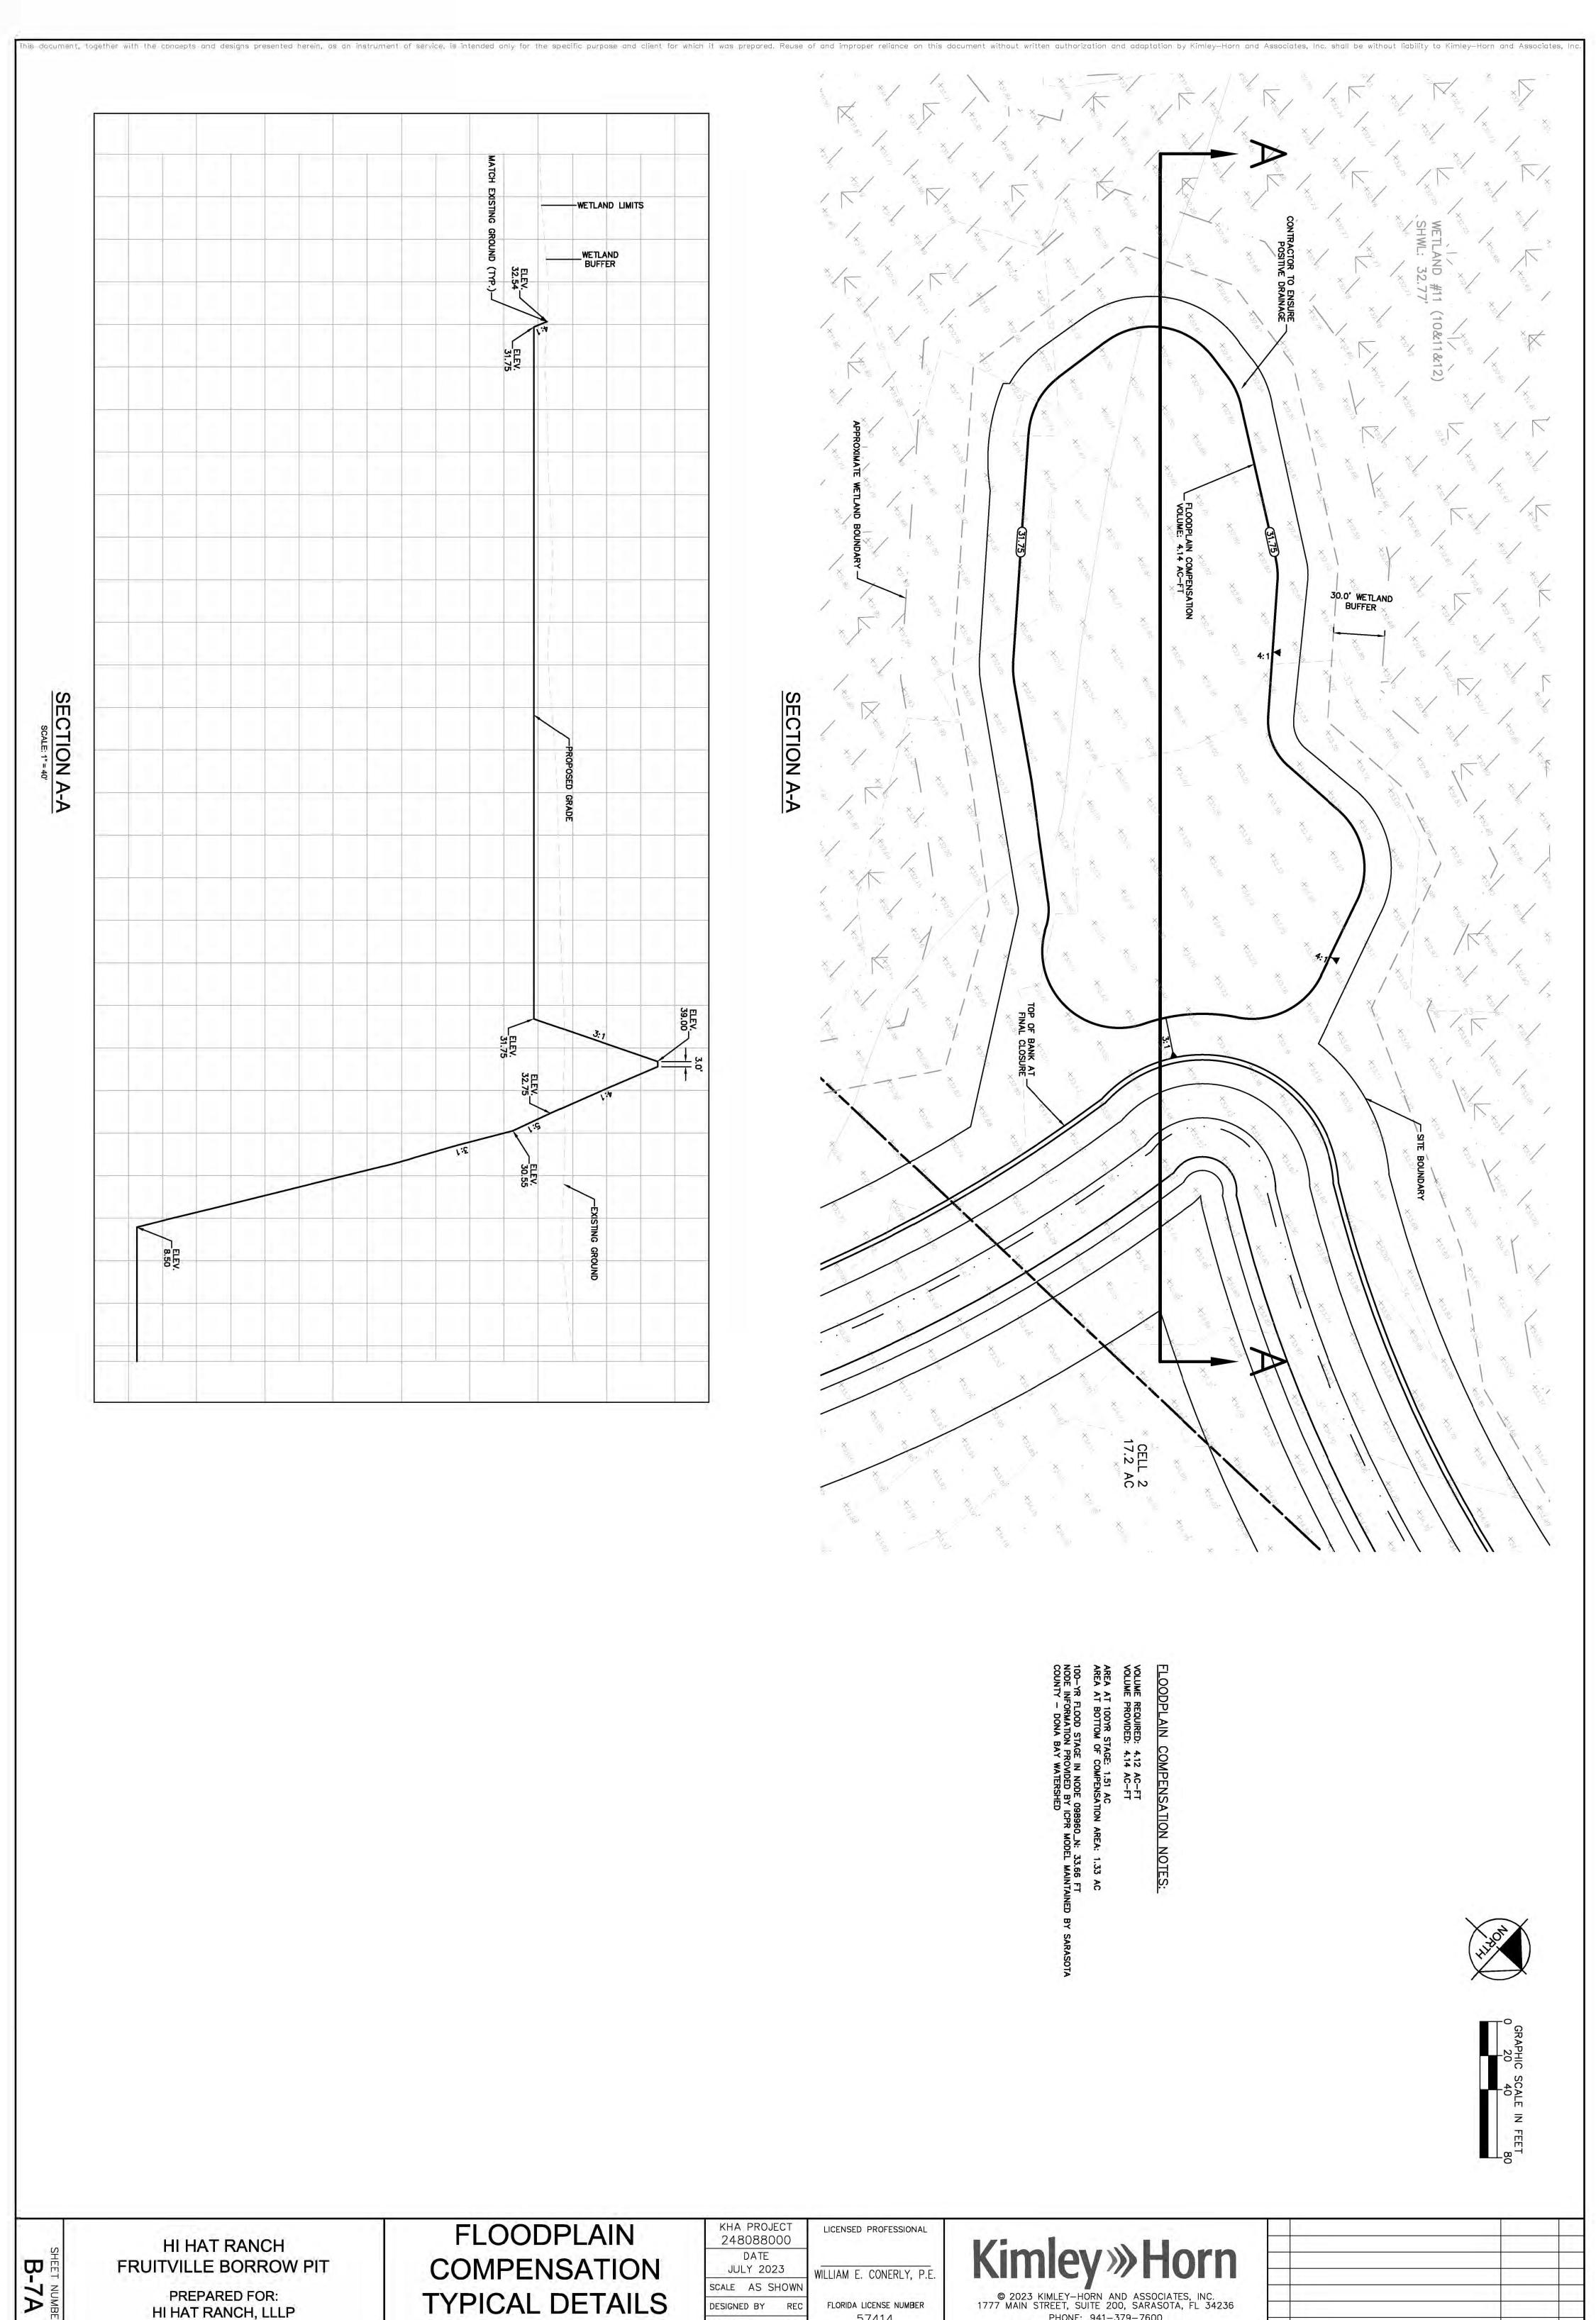FLORIDA SARASOTA COUNTY

TYPICAL DETAILS AND SECTIONS


SCALE AS SHOWN FLORIDA LICENSE NUMBER DESIGNED BY REC 57414 LAB DRAWN BY


WEC DATE:

CHECKED BY

© 2023 KIMLEY-HORN AND ASSOCIATES, INC. 1777 MAIN STREET, SUITE 200, SARASOTA, FL 34236 PHONE: 941-379-7600 WWW.KIMLEY-HORN.COM CA 00035106

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FLOODPLAIN COMPENSATION AREA M-2 NOTES:

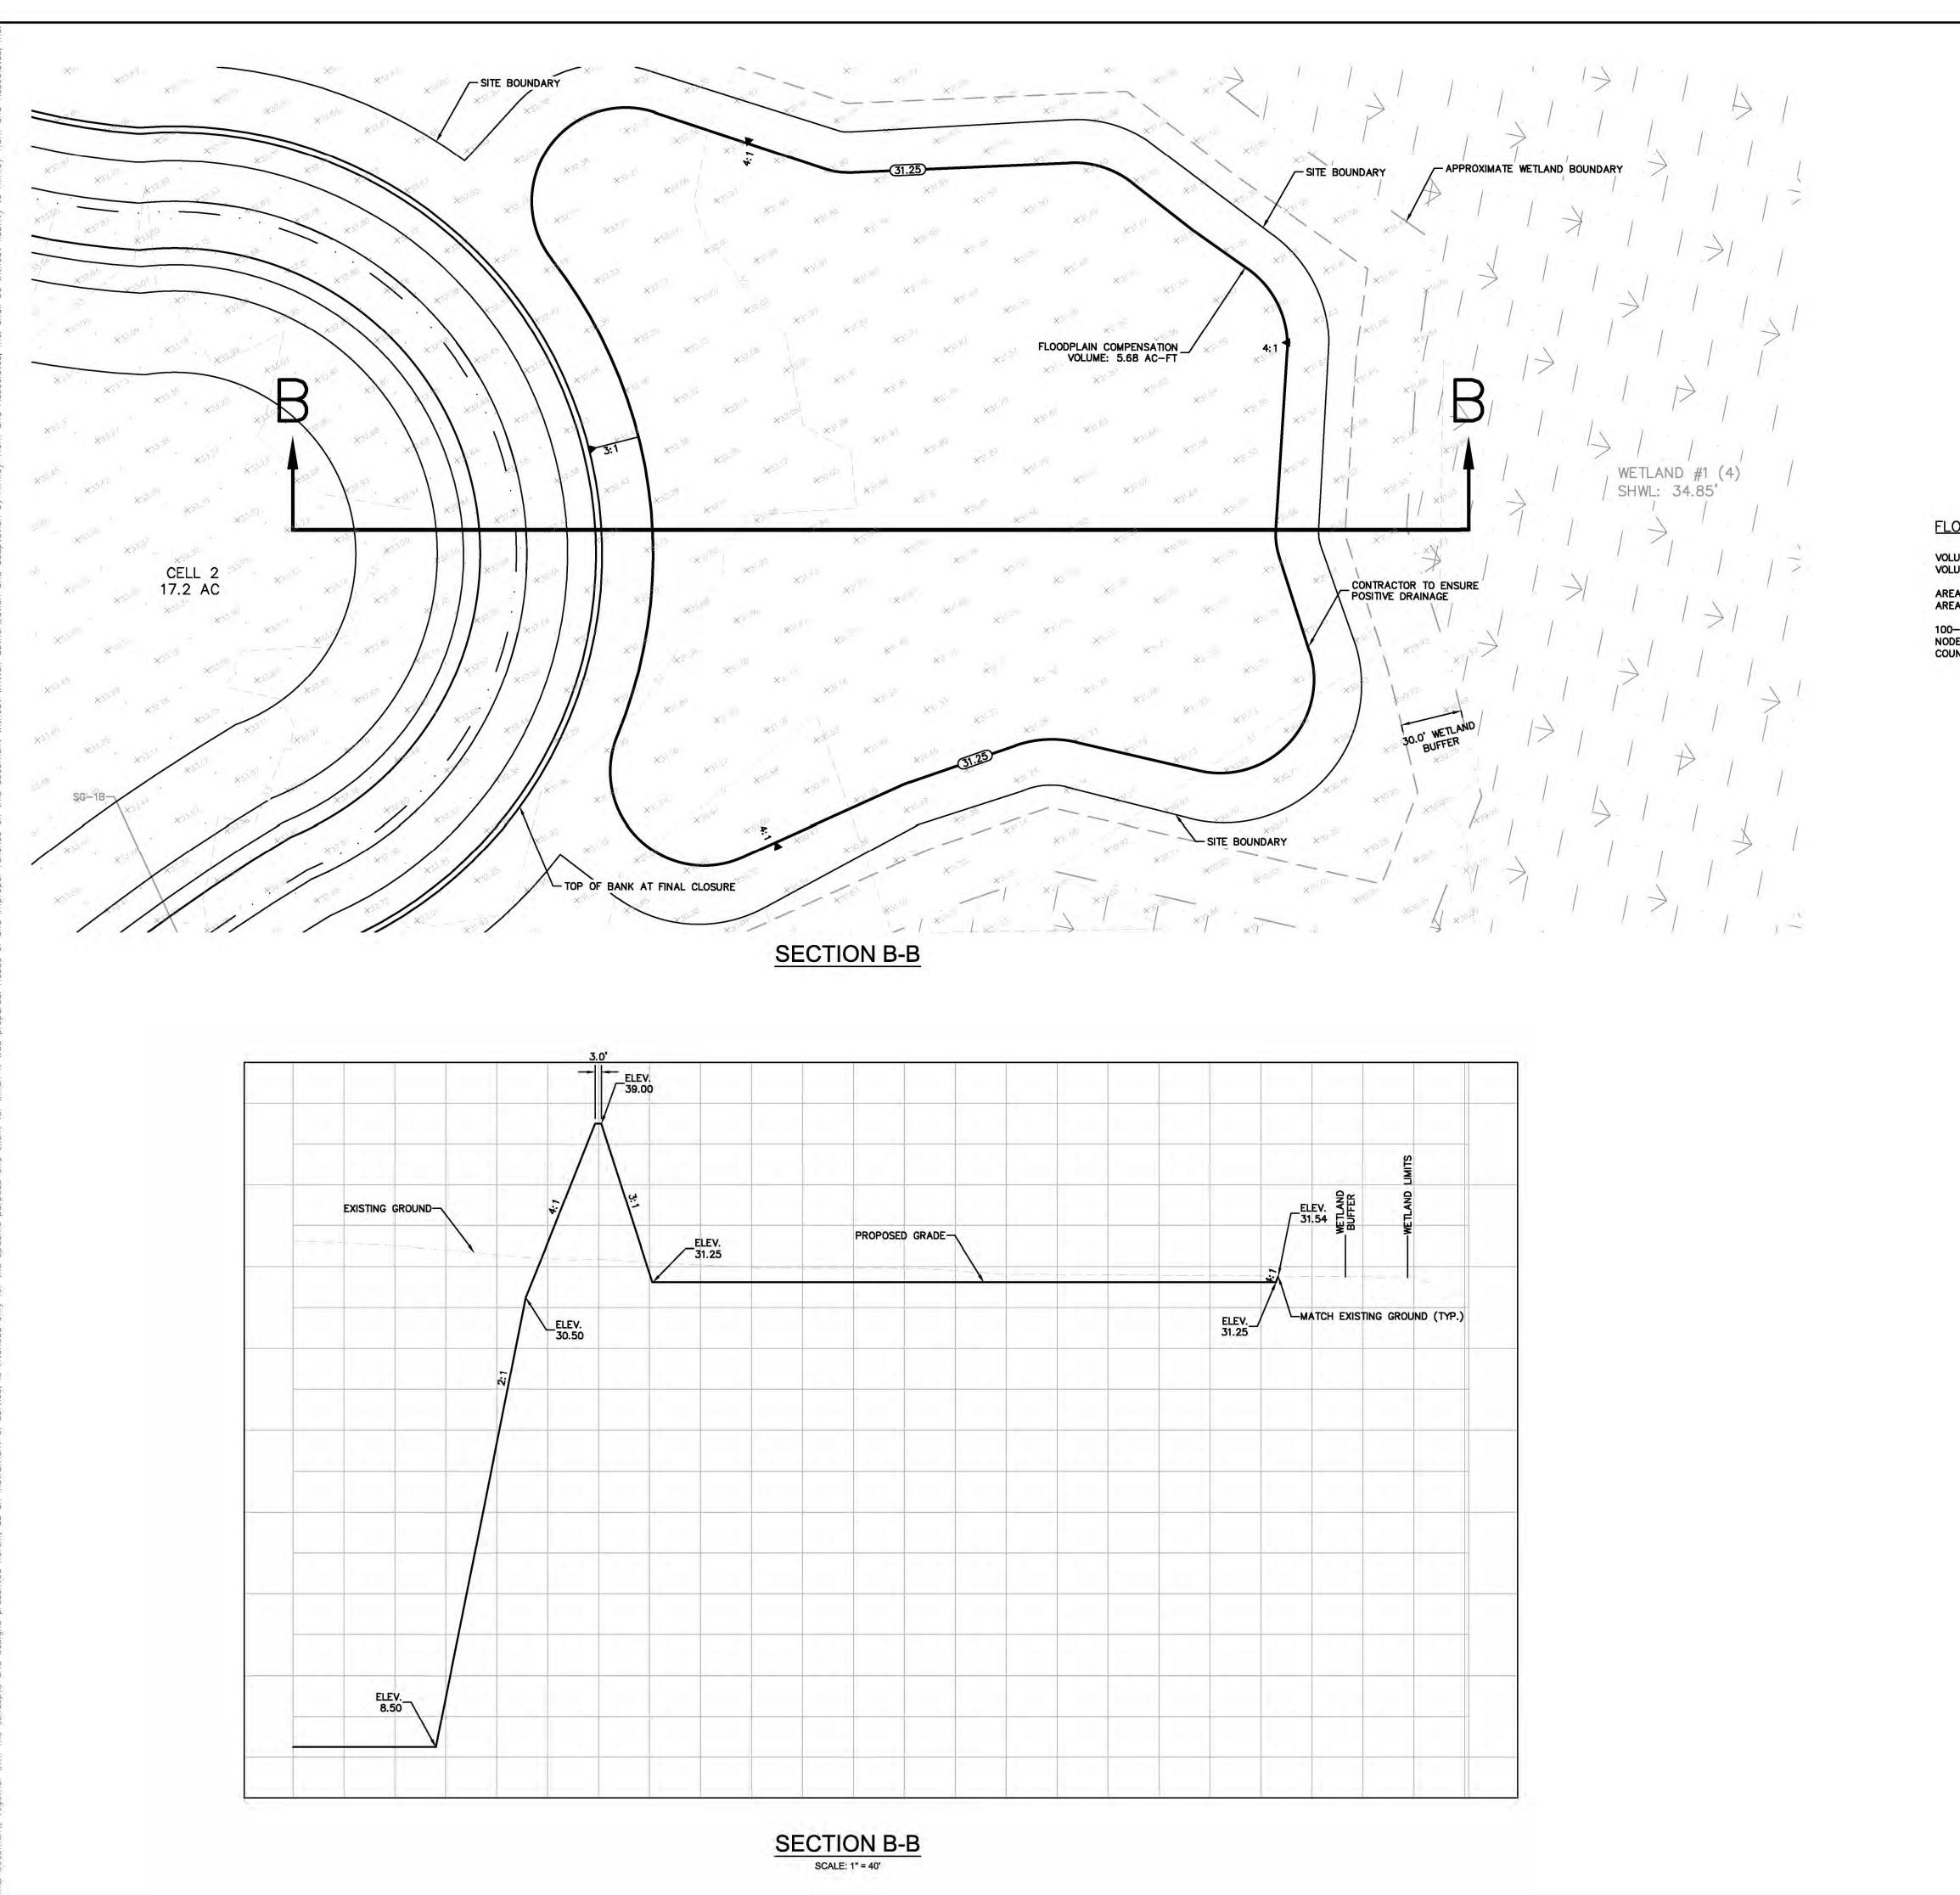VOLUME REQUIRED: 5.67 AC-FT VOLUME PROVIDED: 5.68 AC-FT

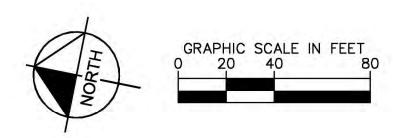
AREA AT 100YR STAGE: 2.21 AC
AREA AT BOTTOM OF COMPENSATION AREA: 2.50 AC

100-YR FLOOD STAGE IN NODE 095290_N: 33.66 FT NODE INFORMATION PROVIDED BY ICPR MODEL MAINTAINED BY SARASOTA COUNTY - DONA BAY WATERSHED

Hor Kimle

HI HAT RANCH FRUITVILLE BORROW PIT PREPARED FOR: HI HAT RANCH, LLLP

SHEET NUMBER **B-7B**

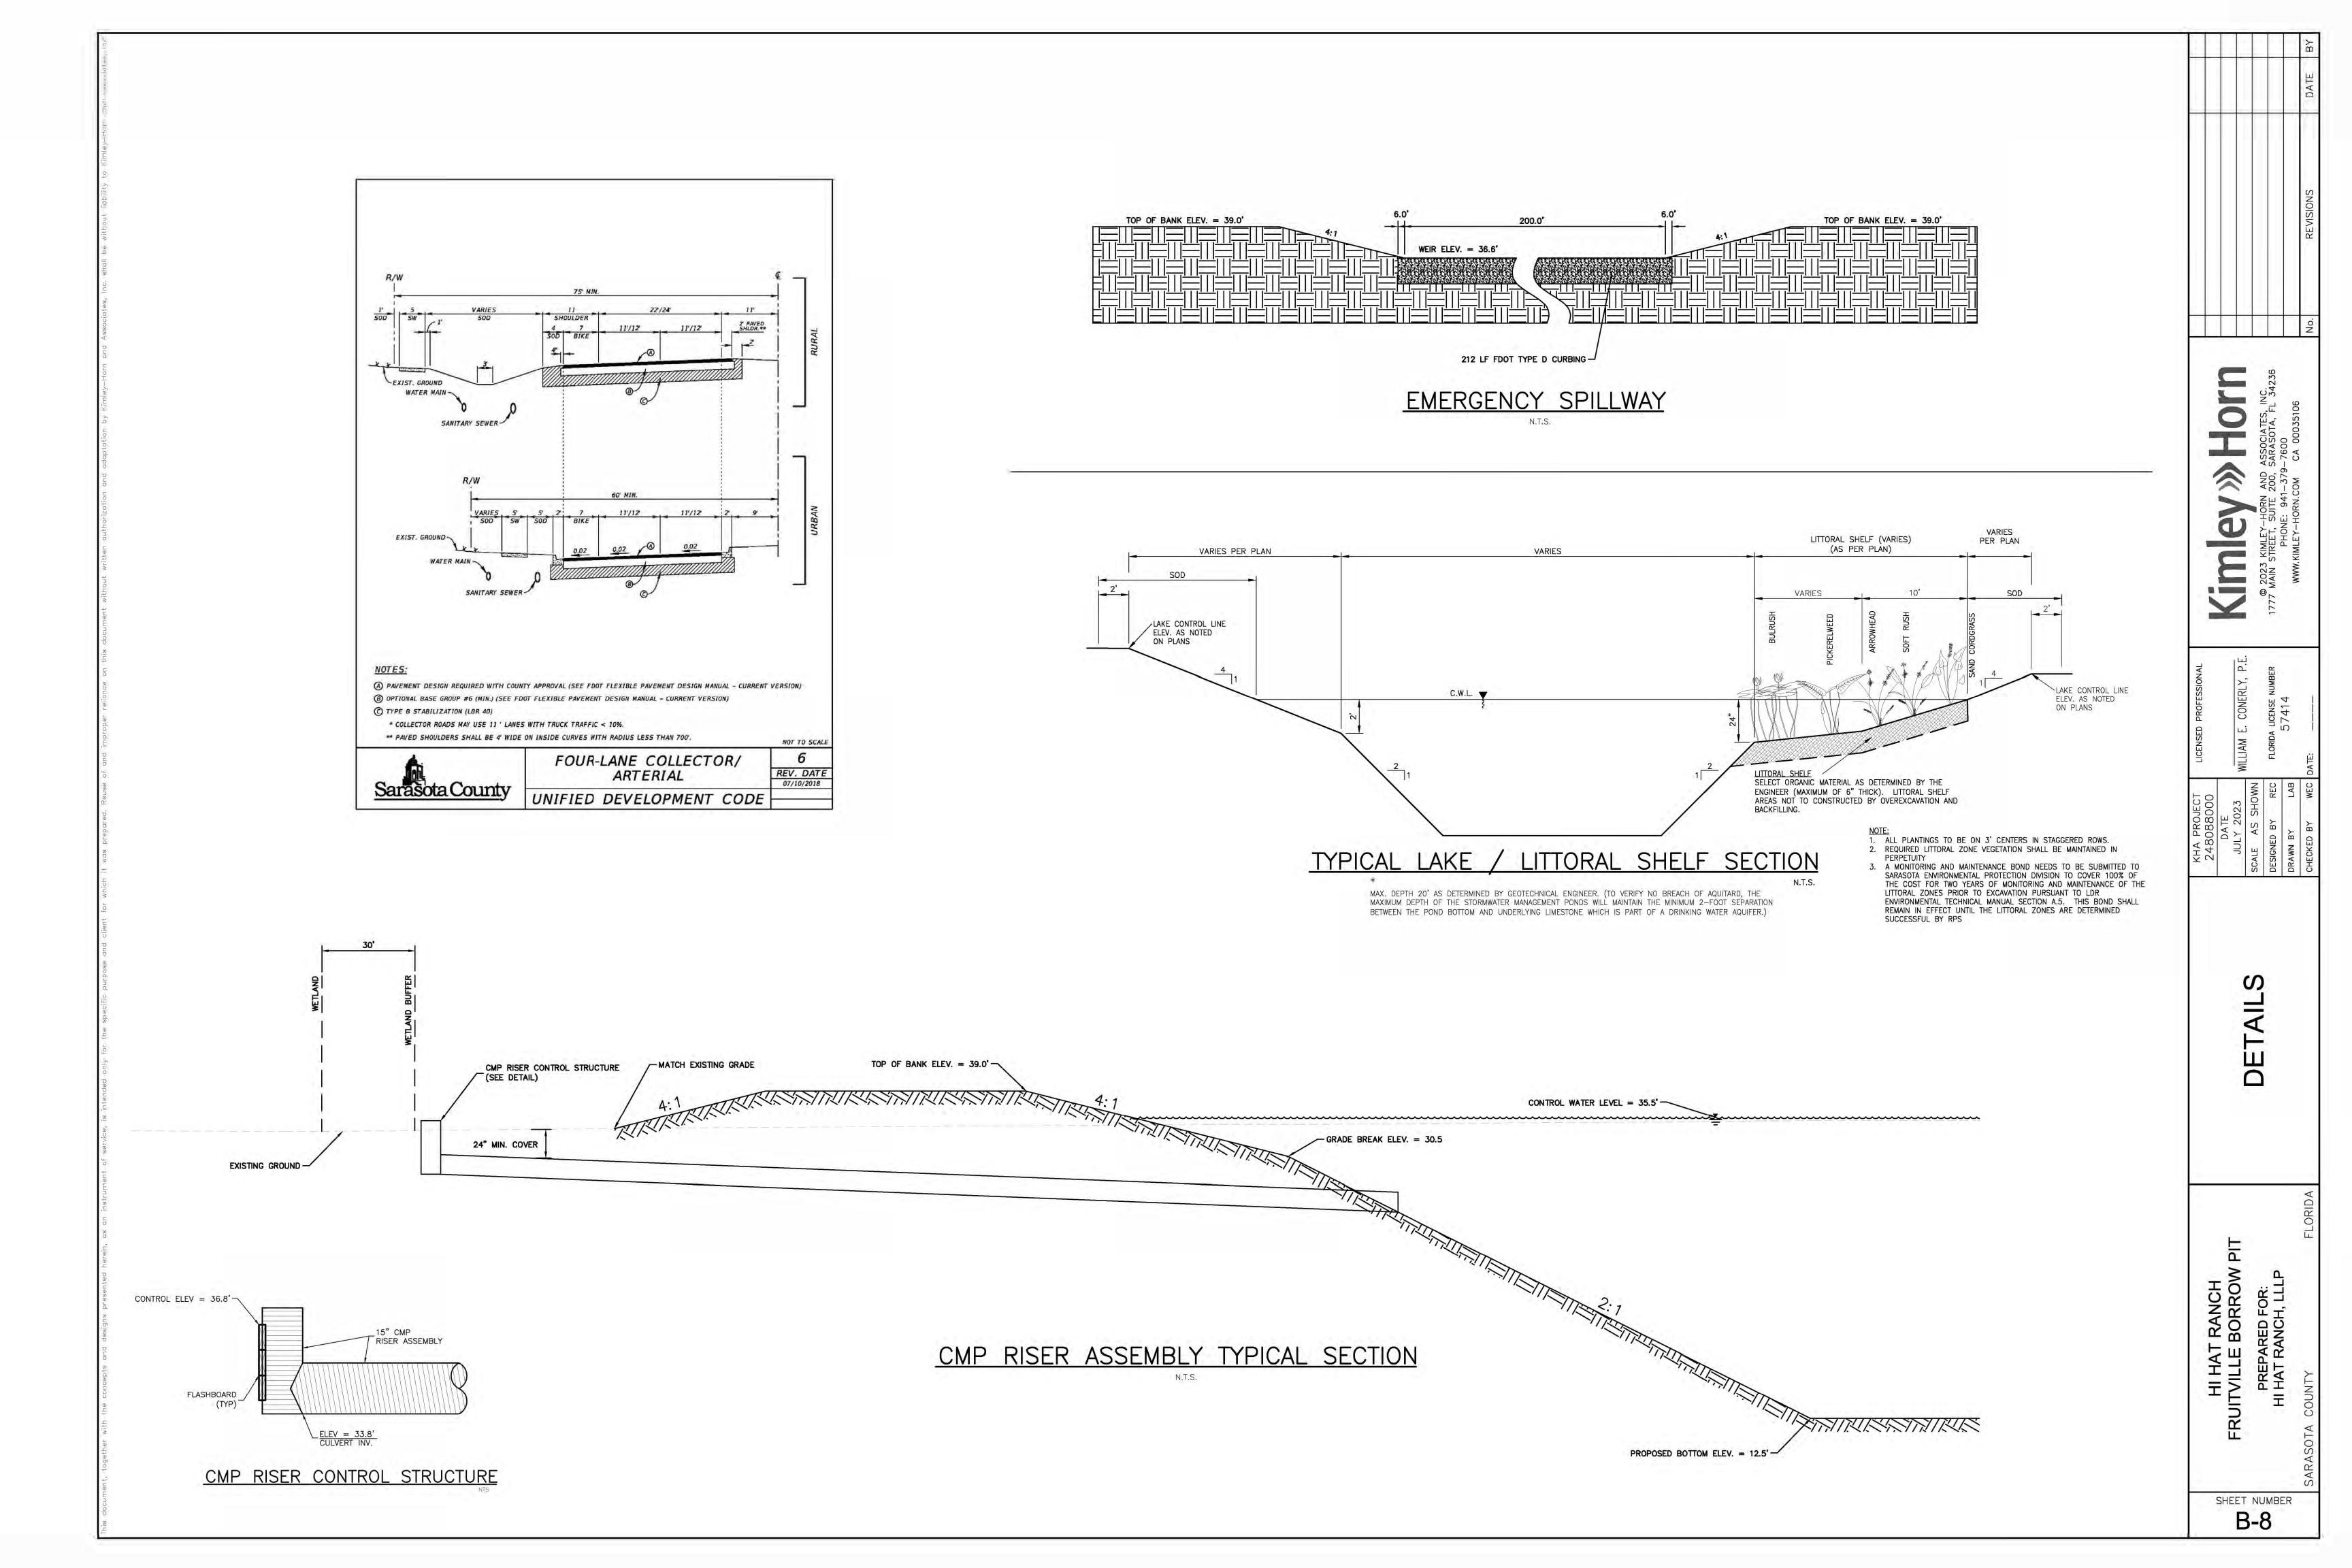



> Hi Hat Ranch Fruitville Borrow Pit Wetland Monitoring and Contingency Plan

> November 2022 (Revised April 2023) ECT No. 150272-0100

Hi Hat Ranch, LLLP 11708 Fruitville Road Sarasota, Florida



> Hi Hat Ranch Fruitville Borrow Pit Wetland Monitoring Plan Sarasota County **Document Review** The dual signatory process is an integral part of Environmental Consulting & Technology, Inc.'s (ECT's) Document Review Policy. All ECT documents undergo technical/peer review prior to dispatching these documents to any outside entity. This document has been authored and reviewed by the following employees: April 24, 2023

> Hi Hat Ranch Fruitville Borrow Pit Wetland Monitoring Plan Sarasota County

Table of Contents

| 1.0 | Intr | oduction | 1-1 |
|-----|------|-----------------------|-----|
| 2.0 | Mor | nitoring Methodology | 2-1 |
| | 2.1 | Vegetation Monitoring | 2-1 |
| | 2.2 | Hydrologic Monitoring | 2-1 |
| | 2.3 | Reporting | 2-2 |
| 20 | C | 41 | 2.4 |

List of Tables

Table 2-1. Proposed Monitoring Well Locations for Hi Hat Fruitville Borrow Pit.

List of Figures

Project Location Map Wetland Monitoring Plan > Hi Hat Ranch Fruitville Borrow Pit Sarasota County

Wetland Monitoring Plan

1.0 Introduction

Environmental Consulting & Technology, Inc. (ECT) is providing a monitoring plan to Hi Hat Ranch, LLLP for a new borrow pit project in order to provide reasonable assurance that there will be no adverse secondary impacts to the existing natural resources. The proposed Hi Hat Ranch Fruitville Borrow Pit (Project Area) is approximately 155.7 acres in size, located approximately four (4) miles east of Interstate 75 along the south side of Fruitville Road across from Vic Edwards Road in Sections 23 and 24, Township 36S, and Range 19E, Sarasota County (Figure 1). A pre-application meeting was held on October 13, 2022, with Southwest Florida Water Management District (SWFWMD) staff to discuss the project. A site review with WUP and ERP staff was conducted on March 28, 2023.

The borrow pit will be excavated in three (3) cells for a total of 115.8 acres of excavated pits. Excavation of material will start in Cell 1, then move to Cell 2 and finishing with Cell 3. Each cell will have a corresponding recharge trench. Construction of the recharge trenches and subsequent installation of the monitoring devices will be phased along with cell construction and dewatering activities. Recharge trenches will be constructed to provide a hydraulic barrier to adjacent wetland features. A single pump will be used for dewatering each cell. No more than one cell will be dewatered at any one time.

A total of five (5) wetlands (Wetlands 1, 9, 11, 12, and 13) are within 200 feet of the proposed borrow pit. The proposed plan will monitor these wetland systems as part of the qualitative vegetation monitoring component. Monitoring wells will be established in Wetlands 1, 9, 11, 12, and 13 and five (5) staff gauges will be located within the recharge trench near each monitoring well. Two monitoring wells will be located in Wetland 1 due to its expansive extent. Water level data for the surface water monitoring component will be established in Wetland 12; however, a staff gauge will not be installed since the distance between the wetland and recharge trench is greater than 200 feet. The areas to be monitored are shown on Figure 2. The following monitoring plan is to ensure no adverse secondary hydrologic impacts occur to nearby wetlands.

EGT

Wetland Monitoring Plan

2.0 Monitoring Methodology

2.1 <u>Vegetation Monitoring</u>

> Hi Hat Ranch Fruitville Borrow Pit

A total of six (6) vegetation monitoring stations will be established in five wetlands, Wetlands 1, 9, 11, 12, and 13 and will be qualitatively monitored annually. The vegetation monitoring will consist of panoramic photographic documentation from a fixed-point station, positioned toward the wetland, and a description of the dominant vegetative groundcover for the community type(s) within each wetland. If exotic/ nuisance species recruit, increase in cover, or community structure changes including mortality, indicating altered hydroperiods have occurred, then the annual report will reflect the changes. The locations of the fixed-point photo stations are shown in Figure 2.

2.2 **Hydrologic Monitoring**

Weekly water level monitoring by piezometer wells will be provided in Wetlands 1, 9, 11, 12, and 13 surrounding the proposed borrow area. In addition, the monitoring of the water levels in the recharge trench will be conducted via staff gauges in the trench adjacent to the wetlands. A total of five (5) staff gauges will be installed and maintained in the recharge trench. The devices will be surveyed to NAVD (1988) datum to an accuracy of +/- 0.01 foot. All elevations will be surveyed to NAVD (1988) from Fruitville Base Station benchmarks. The proposed locations of each monitoring device are summarized in Table 2-1 below. Once each monitoring device is installed and surveyed, data will be provided to SWFWMD and incorporated into future monitoring reports.

The locations of the proposed piezometers and staff gauges are shown in Figure 2. Water levels will be obtained through field measurements collected weekly, submitted to SWFWMD monthly, and the data will be compiled into an annual summary report due on July 1 of each year. Rainfall data from the nearest weather stations will be collected and analyzed as reference to the water year. The annual summary report will include hydrographs for the period of record, as well as rainfall and discussed in the report. Any mitigation activities will be noted along with specific mention of site receiving past or present water augmentation.

EGT

> Hi Hat Ranch Fruitville Borrow Pit

Wetland Monitoring Plan

EGT

| Description | ID | Monitoring Type | SHWL | Top of Casing (NAVD88) | Ground Elevation (NAVD88) | Total Depth of Well (ft) | Latitude* | Longitude* | Monitoring Frequency |
|----------------|-----------|--------------------|-------|------------------------------|---------------------------------|--------------------------------|-----------|------------|-------------------------|
| Near WL- 1A | SG- 1A | Staff Gauge | 34.85 | TBD | TBD | TBD | 27.335785 | -82.363920 | Weekly |
| WL-1A | MW- 1A | Monitor Well | 34.85 | TBD | TBD | TBD | 27.335178 | -82.363959 | Weekly |
| Near WL- 1B | SG- 1B | Staff Gauge | 30.40 | TBD | TBD | TBD | 27.329699 | -82.366307 | Weekly |
| WL-1B | MW- 1B | Monitor Well | 30.40 | TBD | TBD | TBD | 27.329388 | -82.36665 | Weekly |
| Near WL-9 | SG-9 | Staff Gauge | 32.17 | TBD | TBD | TBD | 27.332502 | -82.373303 | Weekly |
| WL-9 | MW- 9 | Monitor Well | 32.17 | TBD | TBD | TBD | 27.331829 | -82.373301 | Weekly |
| Near WL- 11 | SG- 11 | Staff Gauge | 32.77 | TBD | TBD | TBD | 27.333246 | -82.368380 | Weekly |
| WL-11 | MW- 11 | Monitor Well | 32.77 | TBD | TBD | TBD | 27.332973 | -82.368845 | Weekly |
| Near WL- 13 | SG- 13 | Staff Gauge | 36.72 | TBD | TBD | TBD | 27.336138 | -82.374711 | Weekly |
| WL-13 | MW- 13 | Monitor Well | 36.72 | TBD | TBD | TBD | 27.336537 | -82.375594 | Weekly |
| WL-12 | MW- 12 | Monitor Well | 37.74 | TBD | TBD | TBD | 27.337423 | -82.370913 | Weekly |

Table 2-1. Proposed Monitoring Well Locations for Hi Hat Fruitville Borrow Pit.

2.3 Reporting

The results of the above vegetation data and groundwater monitoring data will be compiled and submitted to SWFWMD annually on July 1 of each year. During the monitoring event, qualitative monitoring consisting of representative photos will be collected from a fixed-point station to document percent cover of both desirable species and nuisance and exotic species that would be indicative of altered hydroperiod (Figure 2). The proposed monitoring time frame will be five (5) years to fulfill ERP requirements but will continue throughout the term of the permit to fulfill the WUP conditions. Should the results of the monitoring indicate any adverse impacts, remedial measures will be implemented.

EGT

> Hi Hat Ranch Fruitville Borrow Pit

Wetland Monitoring Plan

EGT

EGT

3.0 Contingency

During the peak of the wet season, if the water level near the staff gauges is significantly lower (i.e., more than 12 inches below the normal water level observed in the adjacent wetland during the wet season), then the condition and design of the recharge trench will be thoroughly evaluated. Any accumulated sediments in the recharge trench will be removed, and the water level in the wetlands will be closely observed afterwards to determine if the water level has recovered to within 12 inches of the normal water level observed in the adjacent wetland during the wet season. If the water level in the staff gauges has not recovered, the design of the recharge trench will be re-evaluated to see if the trench should be deepened or extended closer to the wetlands.

WETLAND MONITORING P

0

- RANCH BORROW

SHEET NUMBER B-9